SITE INFORMATION

Application for Chapter 40B Project Eligibility / Site Approval

for MassHousing-Financed and New England Fund ("NEF") Homeownership Projects

Section 2: EXISTING CONDITIONS / SITE INFORMATION

In order to issue Site Approval, MassHousing must find (as required by 760 CMR 56.04 (4)) that the site is generally appropriate for residential development.

Buildable Area Calculations

(Acres)

Total Site Area:

1.08

Wetland Area (per MA DEP):

0.43

Flood Hazard Area (per FEMA):

0.00

Endangered Species Habitat (per MESA):

0.00

Conservation / Article 97 Land:

0.00

Protected Agricultural Land (i.e. EO 193):

0.00

Other Non-Buildable:

0.00

Total Non-Buildable Area:

0.43

Total Buildable Area:

0.65

Current use of the site and prior use if known:

1021 Mass Ave: Professional office/ residential 1025-1027 Mass Ave: Multifamily (non-conforming)

Is the site located entirely within one municipality? Yes

If not, in what other municipality is the site located? n/a

How much land is in each municipality? n/a

Additional Site Addresses:

Tax Parcel ID
055.0-0002-0019.0

Current zoning classification and principal permitted uses:

B1 Neighborhood Office

Previous Development Efforts

Please list any previous applications pertaining to construction on or development of the site, including (i) type of application (comprehensive permit, subdivision, special permit, etc.); (ii) application filing date; (iii) date of denial, approval or withdrawal. Also indicate the current Applicant's role, if any, in the previous applications.

Note that, pursuant to 760 CMR 56.03 (1), a decision of a Zoning Board of Appeals to deny a Comprehensive Permit, or (if the Statutory Minima defined at 760 CMR 56.03 (3) (b or c) have been satisfied) grant a Comprehensive Permit with conditions, shall be upheld if a related application has previously been received, as set forth in 760 CMR 56.03 (7).

MHFA Application ID: 103

To the best of your knowledge, has this site ever been rejected for project eligibility/site approval by another subsidizing agency or authority? N_0

If Rejected, Please Explain:

n/a

Existing Utilities and Infrastructure	Yes/No	Description
Wastewater- private wastewater treatment	No	No existing or proposed septic
Wastewater - public sewer	Yes	Public sewer in Mass Ave
Storm Sewer	No	Storm water infiltration is proposed
Water-public water	Yes	Public domestic water in Mass Ave
Water-private well	No	
Natural Gas	Yes	Natural gas in Mass Ave
Electricity	Yes	Power in Mass Ave
Roadway Access to Site	Yes	
Sidewalk Access to Site	Yes	
Other	No	

Describe Surrounding Land Uses:

Surrounding land uses are comprised of single and two family housing, multi family apartment housing, neighborhood offices, retail, fire station, high school, and places of worship.

Surrounding Land Use/Amenities	Distance from Site	Available by Public Transportation?
Shopping Facilities	1.10	Yes
Schools	0.50	Yes
Government Offices	0.70	Yes
Multi-Family Housing	0.01	Yes
Public Safety Facilities	0.01	Yes
Office/Industrial Uses	0.01	Yes
Conservation Land	0.01	Yes
Recreational Facilities	0.40	Yes
Houses of Worship	0.70	Yes
Other	0.00	N/A

Public transportation near the Site, including type of transportaion and distance from site:

Site Characteristics and Development Constraints

Are there any easements, rights of way or other restrictions of record affecting the development of the site? No Is there any evidence of hazardous, flammable or explosive material on the site? No Is the site, or any portion thereof, located within a designated flood hazard area? No Does the site include areas designated by Natural Heritage as endangered species habitat? No Are there documented state-designated wetlands on the site? Yes Are there documented vernal pools on the site? No Is the site within a local or state Historic District or listed on the National Register or Historic Places? No Has the site or any building(s) on the site been designated as a local, state or national landmark? No Are there existing buildings and structures on site? Yes Does the site include documented archeological resources? No Does the site include any known significant areas of ledge or steep slopes? Yes


MHFA Application ID: 103 Page 8 of 27

Existing Conditions Plan


Aerial Photographs



Map View: 1021 & 1025 Mass Avenue indicated in red box

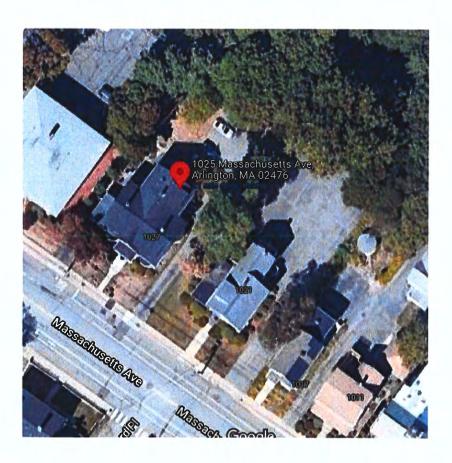


Aerial View: 1021 & 1025 Mass Avenue

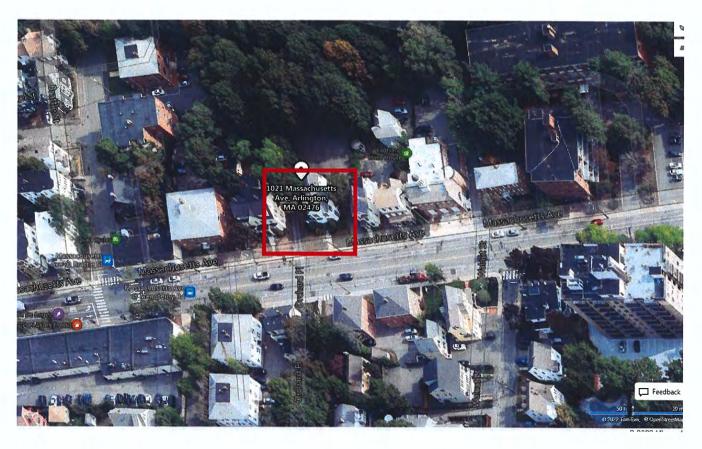

Birdseye View: 1021 & 1025 Mass Avenue indicated in red box



Aerial View: Rear of properties

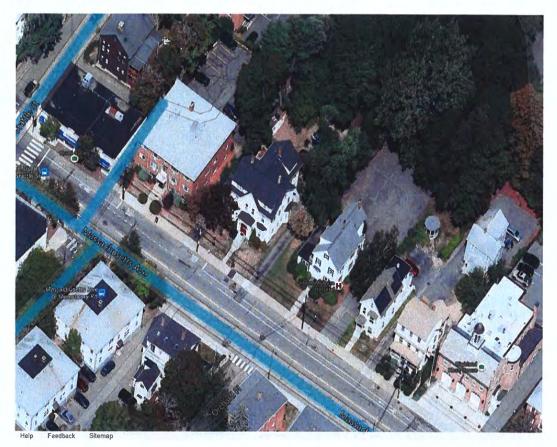


Birdseye View: Street Block




Birdseye View: Rear of Properties (Mill Brook)

Site/Context Photographs

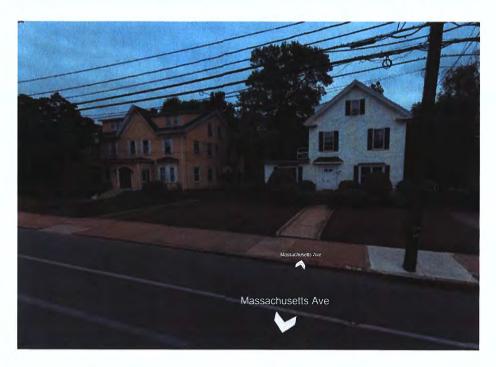

Street View - 1021 & 1025 Mass Avenue

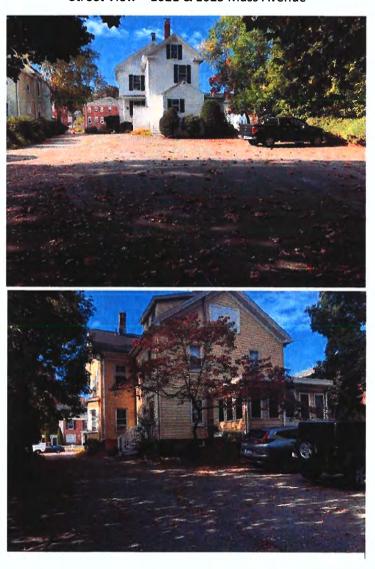

Northerly views of 1021 (top) and 1025 (bottom) structures and parking lots



Westerly view of wooded upland within northern portion of site



Easterly view of parking lot separating site from Mill Brook




View from property down Mass Ave (East)



View from property down Mass Ave (West)



Map View: 1021 & 1025 Mass Avenue indicated in red box

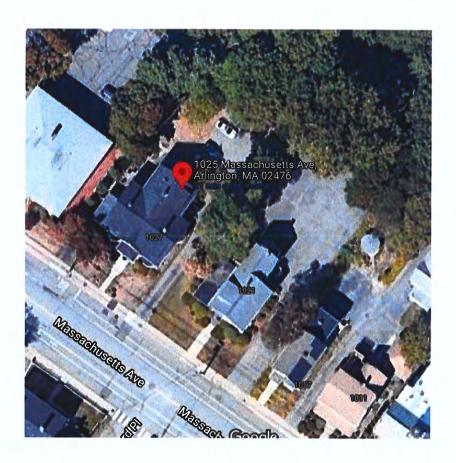


Aerial View: 1021 & 1025 Mass Avenue



Birdseye View: 1021 & 1025 Mass Avenue indicated in red box



Aerial View: Rear of properties

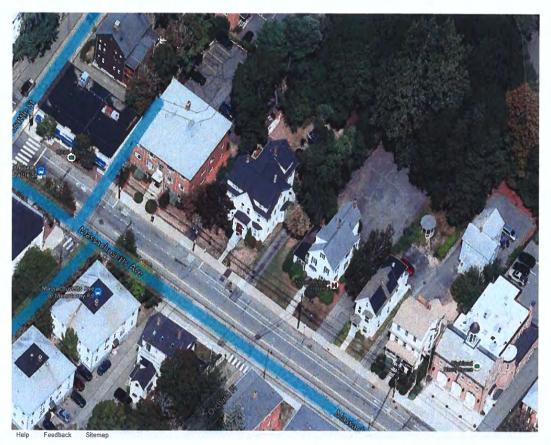


Birdseye View: Street Block



Birdseye View: Rear of Properties (Mill Brook)



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View from property down Mass Ave (East)

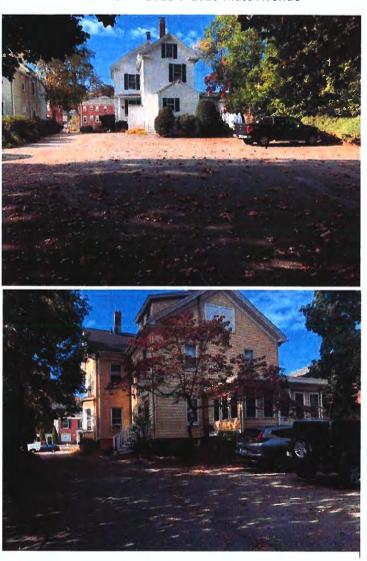


View from property down Mass Ave (West)

Documentation Regarding Site Characteristics/Constraints

- 1. THE INFORMATION DEPICTED ON THIS PLAN HAS BEEN COMPILED FROM THE TOWN OF ARLINGTON
- 2. LAND USE WITHIN 500 FEET OF THE SUBJECT PROPERTY IS PRIMARILY SINGLE FAMILY DWELLINGS

1021 & 1025 MASSACHUSETTS AVENUE (1021 ASSESSORS MAP 55 LOT 19) (1025 ASSESSORS MAP 55 LOT 20) NOTICE OF INTENT PLAN SET

LOCATED IN ARLINGTON, MA APRIL 27, 2022

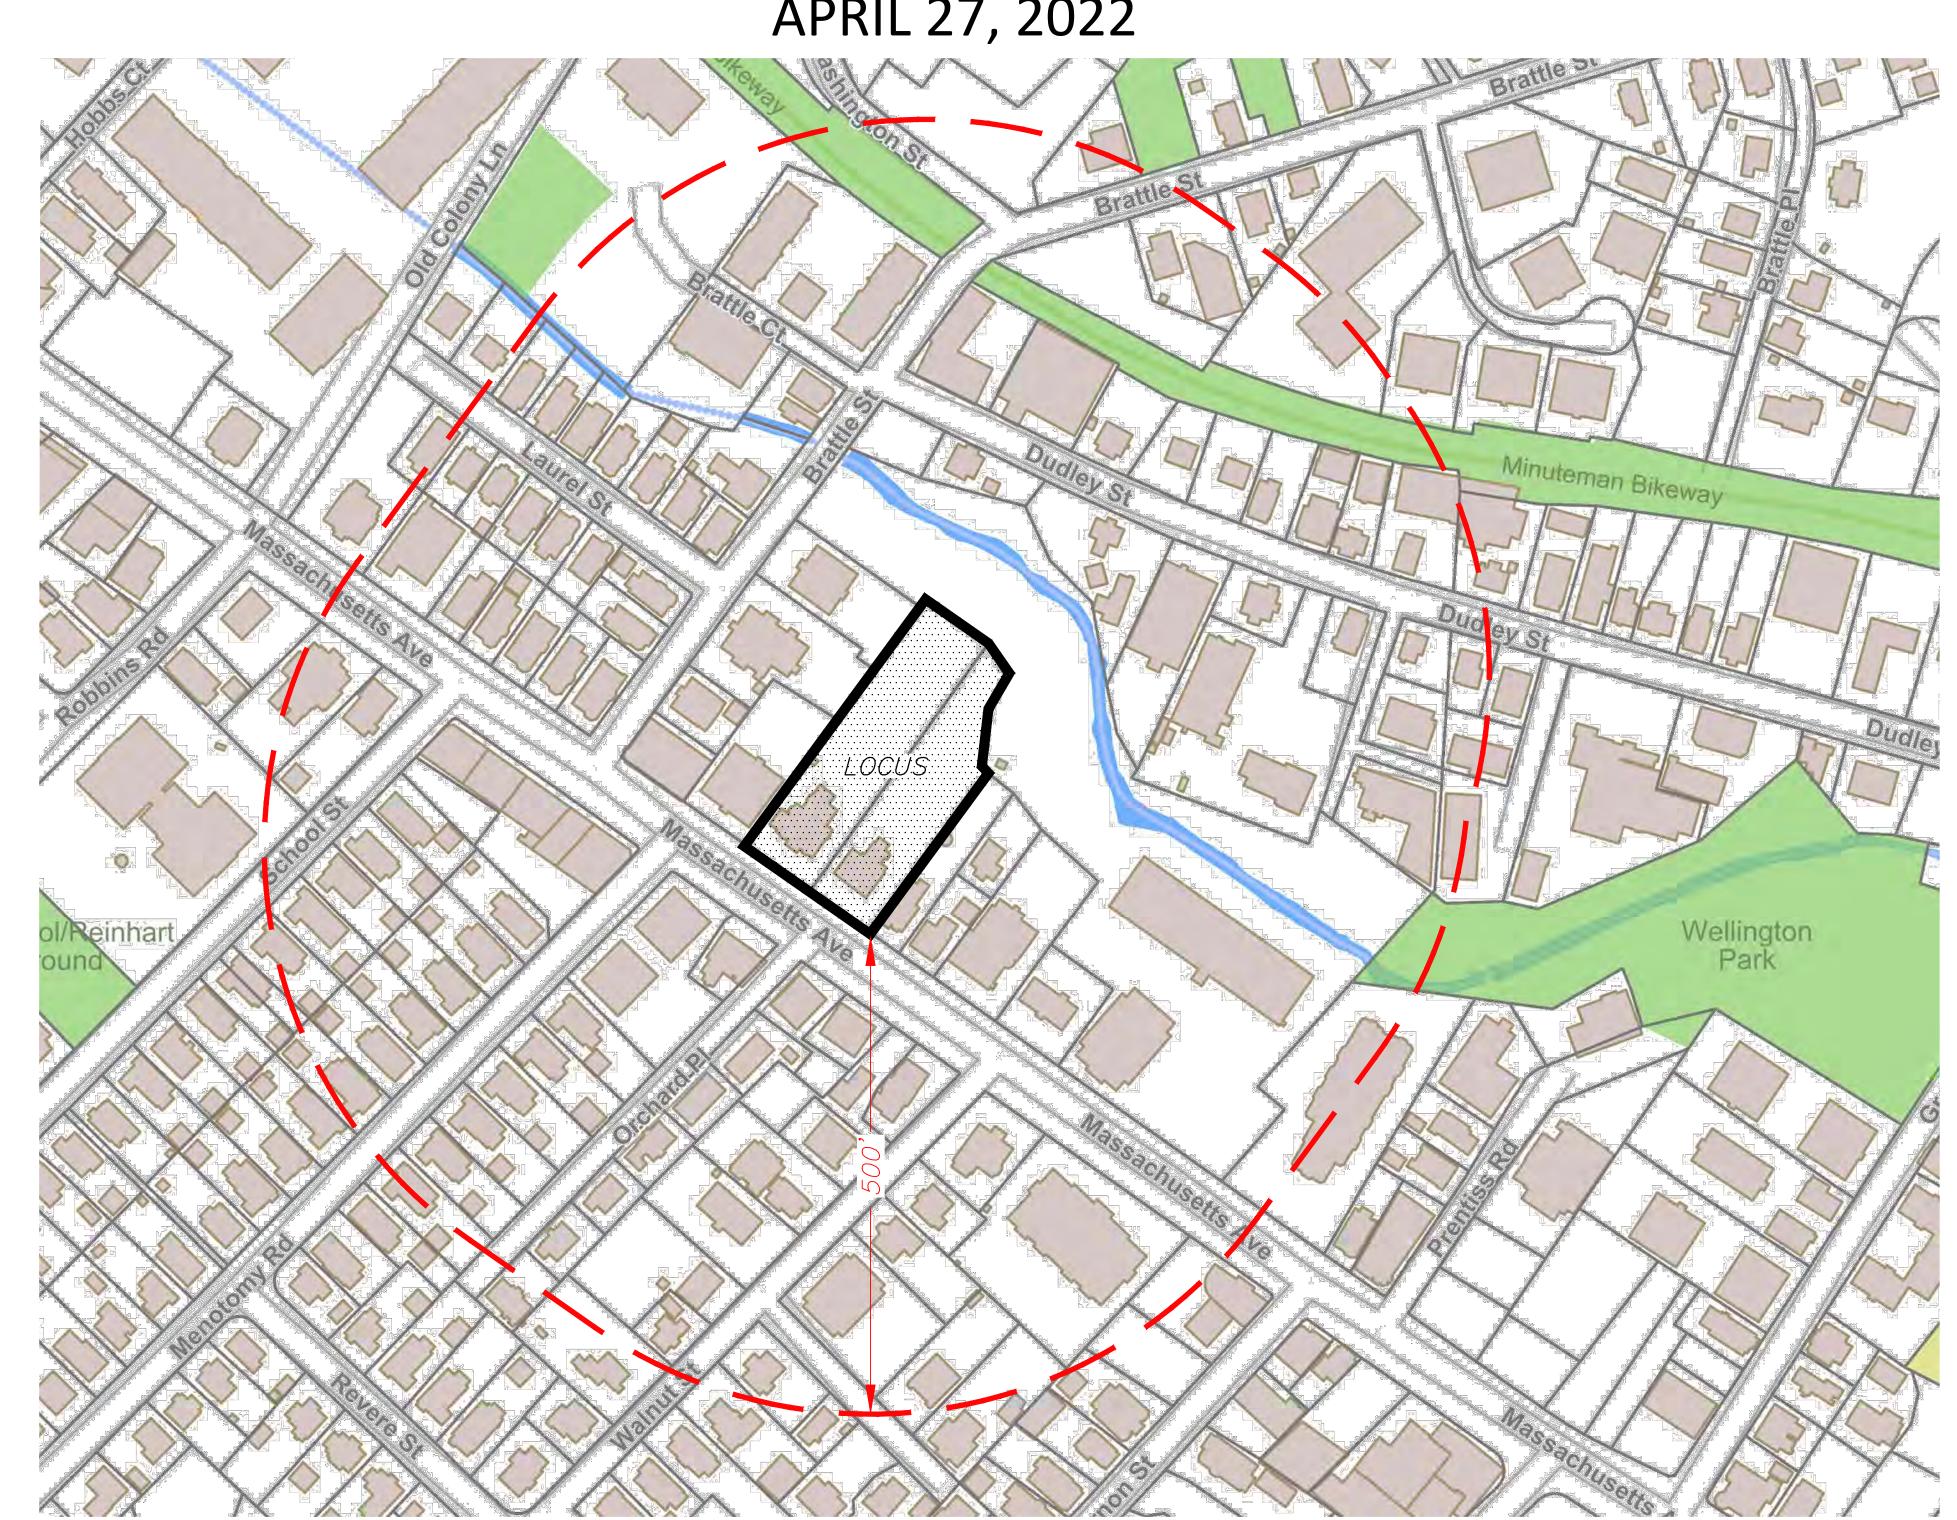

LOCUS CONTEXT MAP

PREPARED BY:






SHEET INDEX

- 1. COVER SHEET
- 2. EXISTING CONDITIONS PLAN
- 3. SITE PLAN
- 4. DETAIL SHEET
- 5. BY RITE SITE PLAN
- 6. FEMA MAP

APPLICANT:

MAJ INVESTMENT, LLC 13 WHEELING AVENUE WOBURN, MA 01801

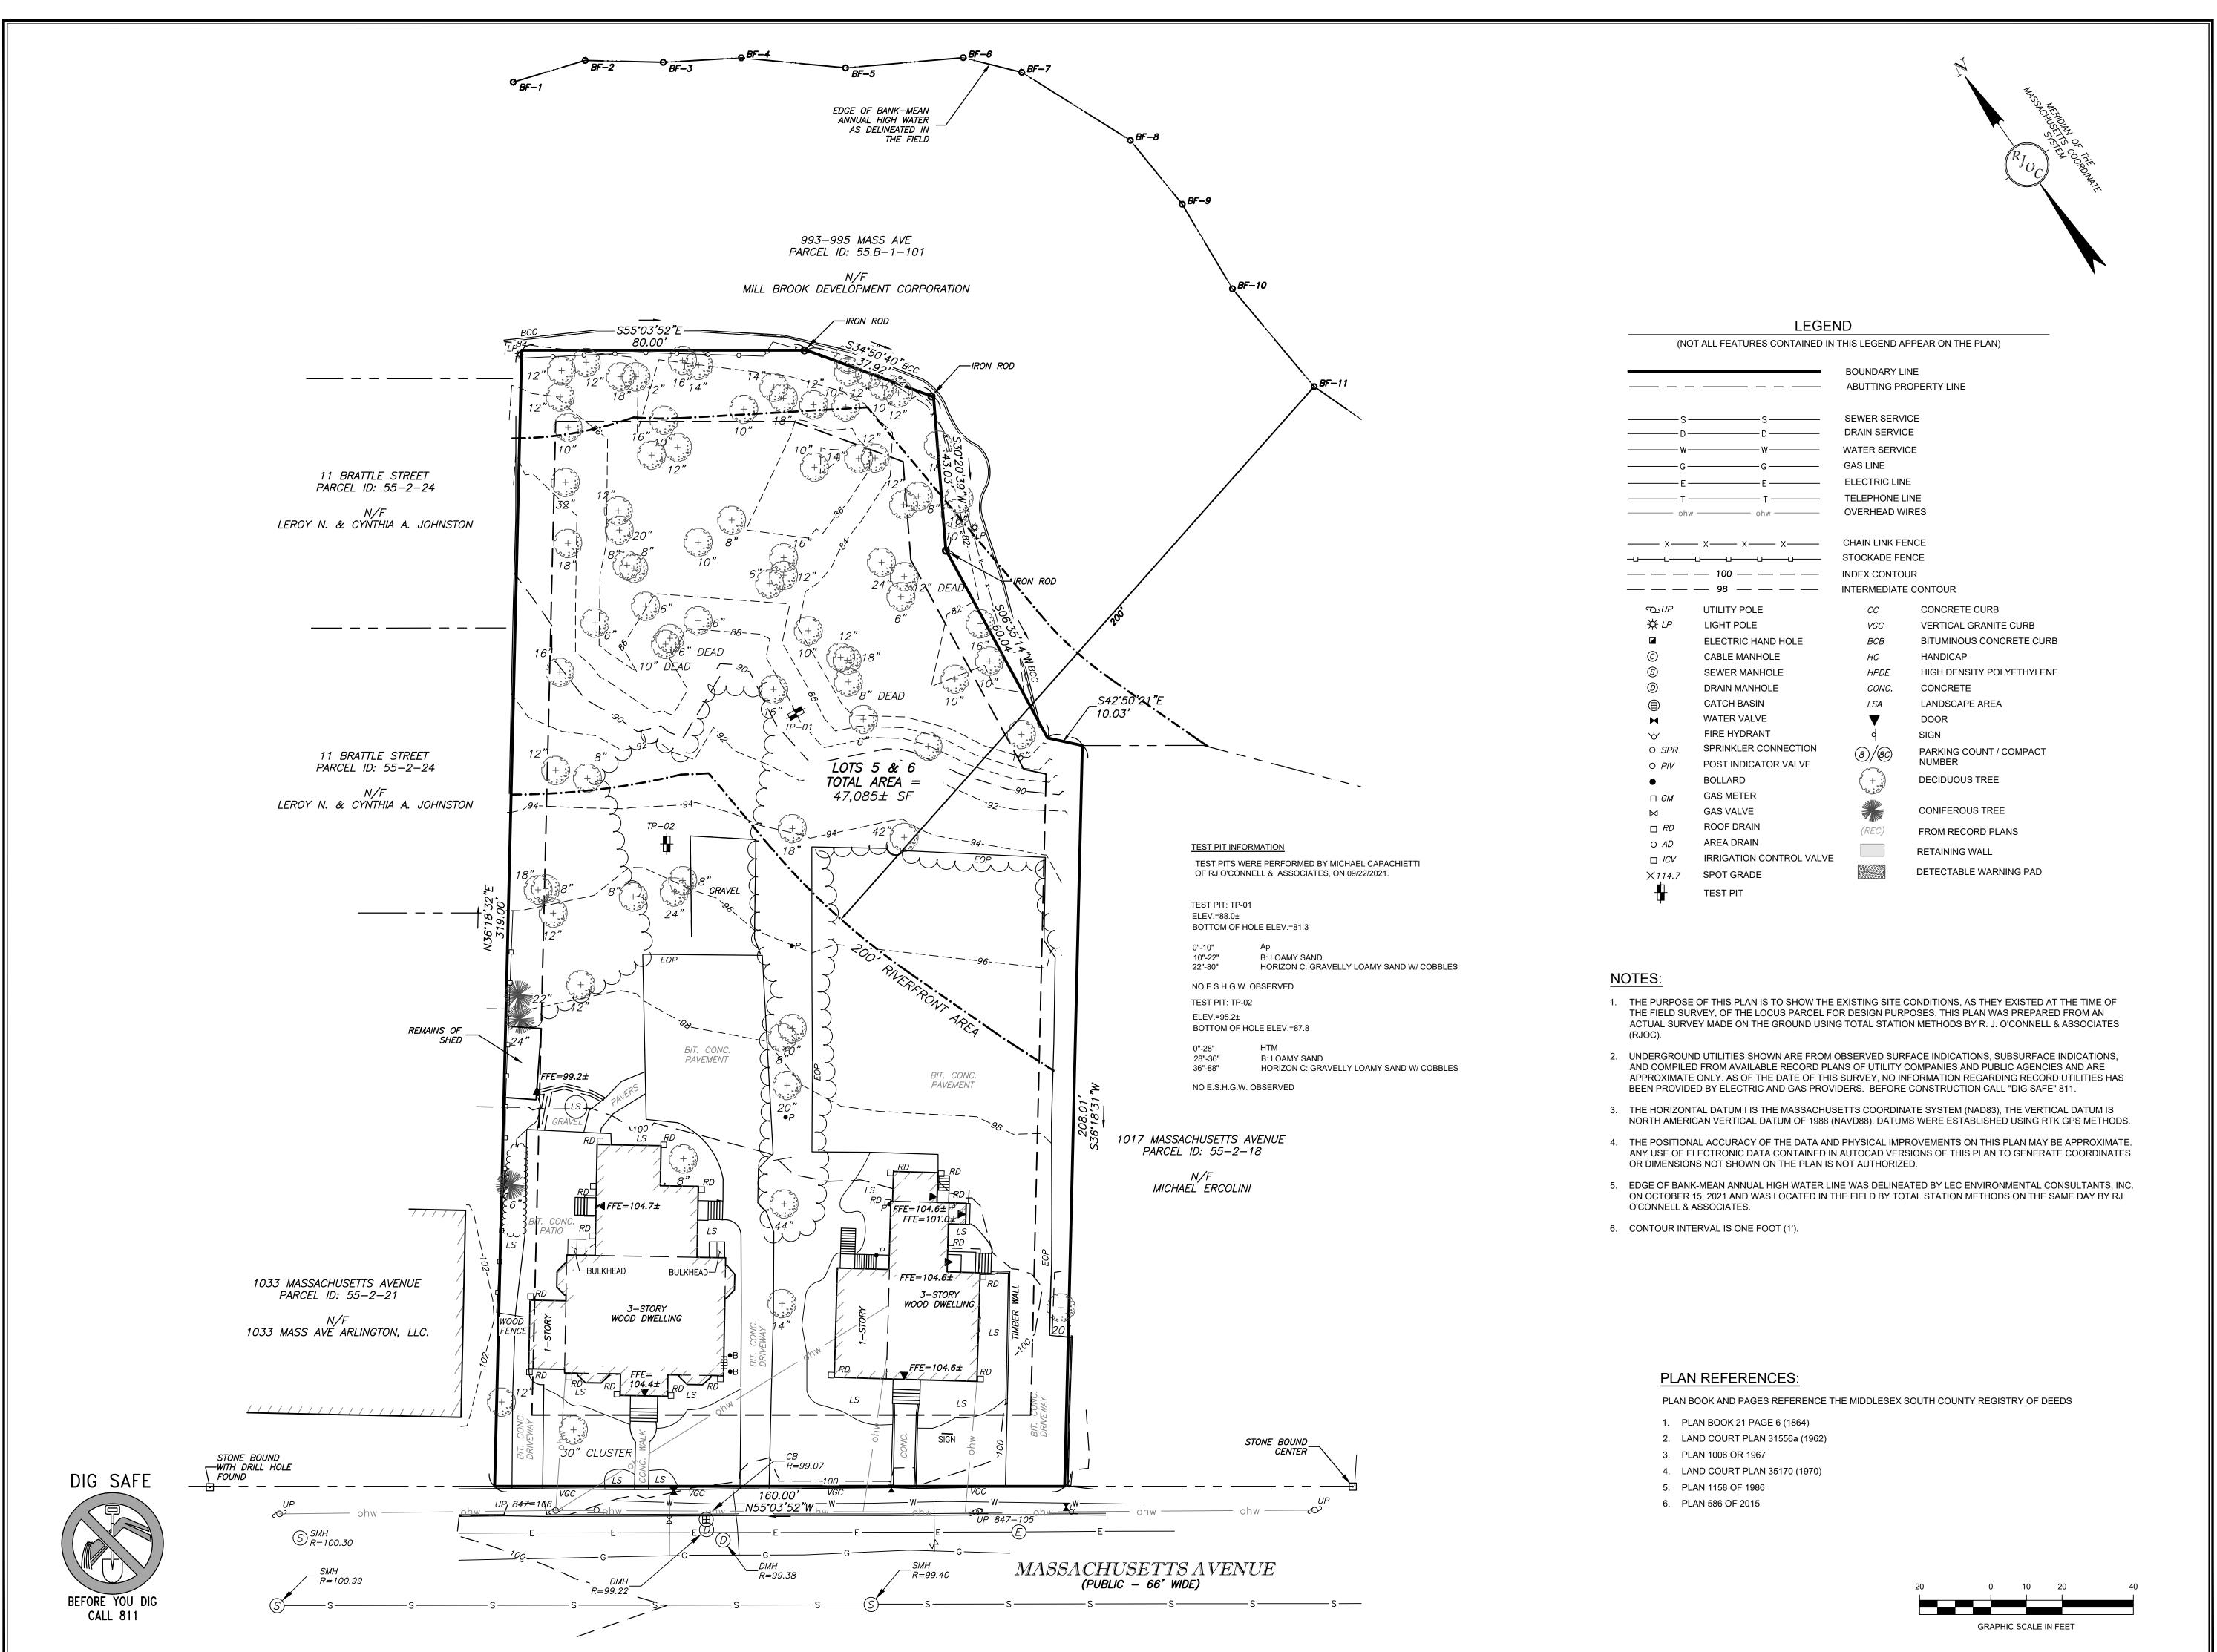

Record Owner: 1021 MASSACHUSETTS AVENUE JOHN H. CHAGLASSIAN 1021 ARLINGTON, MA 02476 BK 72517 / PG 224

1025 - 1027 MASSACHUSETTS AVENUE STEPHEN B. GERSH 21 KING'S COURT ESSEX, MA 01929 BK 57969 / PG 298

Location: PARCEL ID: 1021 MASSACHUSETTS AVENUE MAP 055 BLOCK 002 LOT 019

1025 - 1027 MASSACHUSETTS AVENUE MAP 055 BLOCK 002 LOT 020

ARLINGTON, MA

RJO'CONNELL

& ASSOCIATES, INC.
CIVIL ENGINEERS, SURVEYORS & LAND PLANNERS

80 MONTVALE AVENUE, SUITE 201 STONEHAM, MA 02180 PHONE: 781.279.0180 RJOCONNELL.COM

PATRIOT ENGINEERING, LLC.

35 BEDFORD STREET SUITE 4 LEXINGTON, MA 02420

PROJECT NAME:

1021 & 1025 MASSACHUSETTS AVE

ARLINGTON, MA

THIS PLAN IS THE RESULT OF AN ON THE GROUND SURVEY PERFORMED BETWEEN 08/13/2021 AND 10/15/2021.

PROFESSIONAL LAND SURVEYOR FOR RJ O'CONNELL & ASSOCIATES, INC	DATE
DRAWN BY:	RJK / WJH
REVIEWED BY:	ML
SCALE:	1" = 20'
FIELD CREW:	RJK / CJR
FIELD BOOK:	FIELD BOOK 40 / PG 5
DATE:	10/19/2021
DRAWING NAME:	


EXISTING CONDITIONS PLAN

DRAWING NUMBER:

EX-1

PROJECT NUMBER: 21583

Copyright © 2021 by R.J. O'Connell & Associates, Inc.

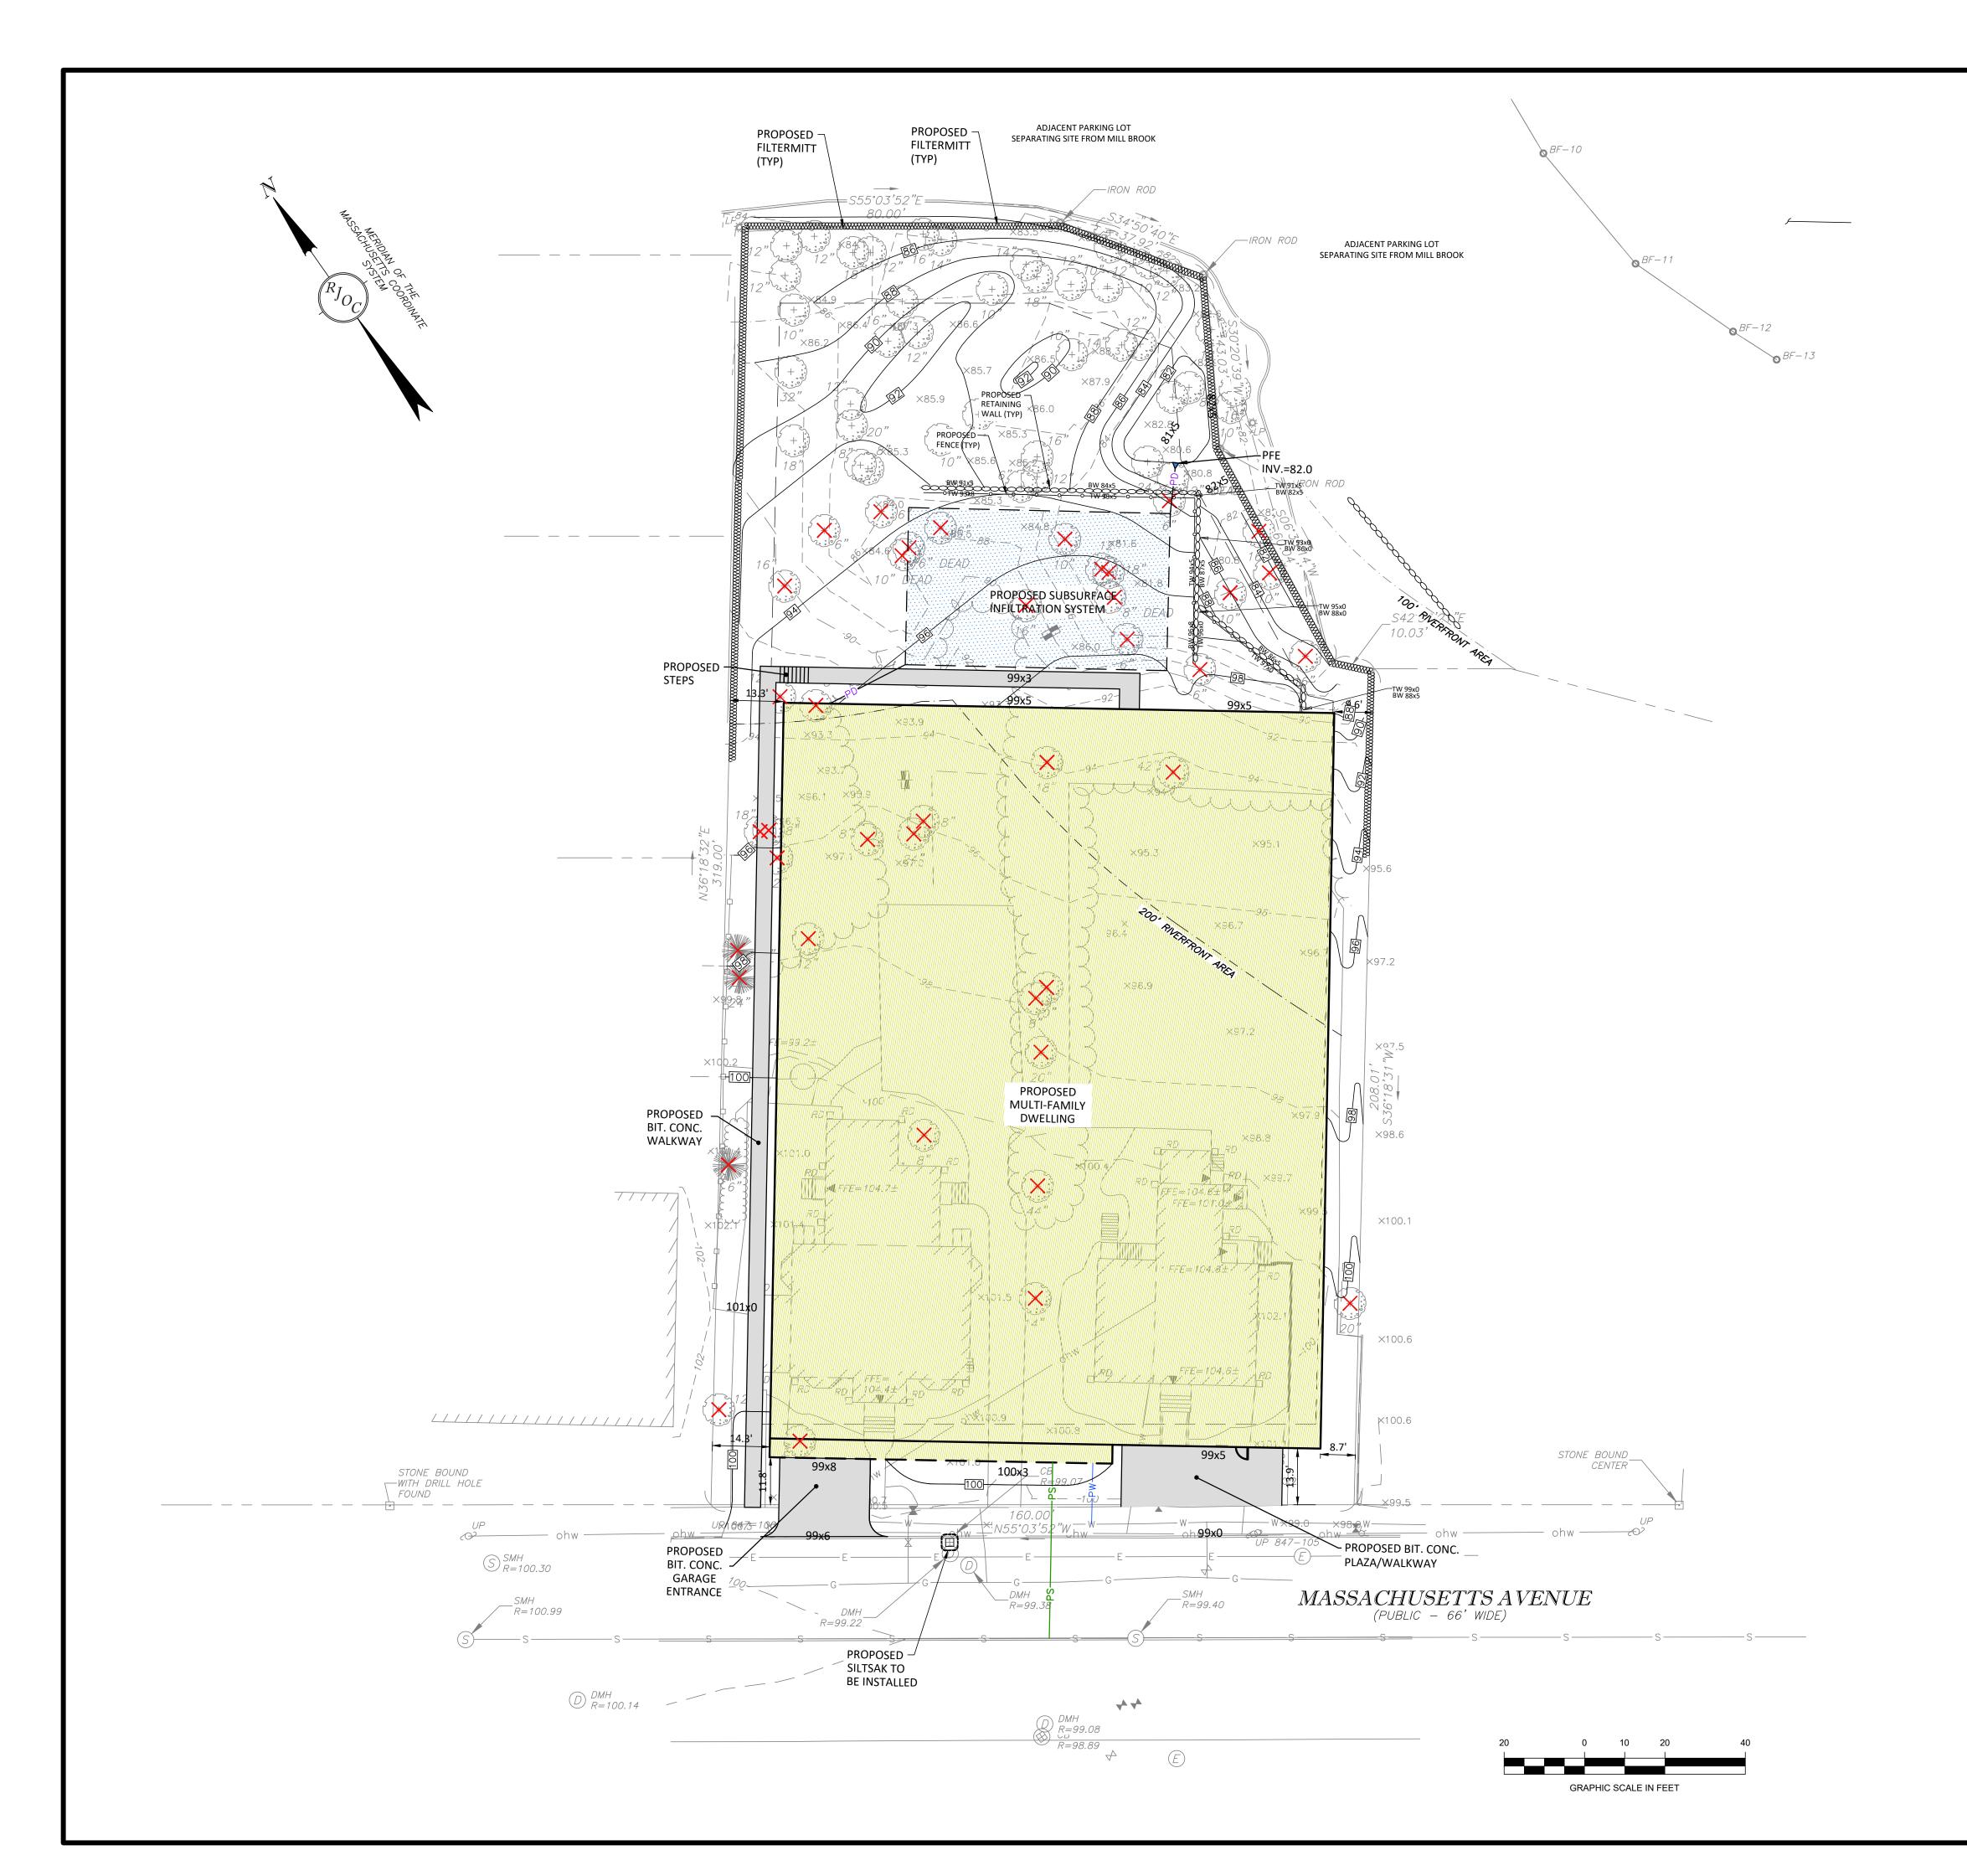

- 1. UNDERGROUND UTILITIES SHOWN ARE FROM OBSERVED SURFACE INDICATIONS, SUBSURFACE INDICATIONS, AND COMPILED FROM AVAILABLE RECORD PLANS OF UTILITY COMPANIES AND PUBLIC AGENCIES AND ARE APPROXIMATE ONLY. AS OF THE DATE OF THIS SURVEY, NO INFORMATION REGARDING RECORD UTILITIES HAS BEEN PROVIDED BY ELECTRIC AND GAS PROVIDERS. BEFORE CONSTRUCTION CALL "DIG SAFE" 811.
- 2. THE HORIZONTAL DATUM I IS THE MASSACHUSETTS COORDINATE SYSTEM (NAD83), THE VERTICAL DATUM IS NORTH AMERICAN VERTICAL DATUM OF 1988 (NAVD88). DATUMS WERE ESTABLISHED USING RTK GPS METHODS.
- 3. THE POSITIONAL ACCURACY OF THE DATA AND PHYSICAL IMPROVEMENTS ON THIS PLAN MAY BE APPROXIMATE. ANY USE OF ELECTRONIC DATA CONTAINED IN AUTOCAD VERSIONS OF THIS PLAN TO GENERATE COORDINATES OR DIMENSIONS NOT SHOWN ON THE PLAN IS NOT AUTHORIZED.
- 4. EDGE OF BANK-MEAN ANNUAL HIGH WATER LINE WAS DELINEATED BY LEC ENVIRONMENTAL CONSULTANTS, INC. ON OCTOBER 15, 2021 AND WAS LOCATED IN THE FIELD BY TOTAL STATION METHODS ON THE SAME DAY BY RJ O'CONNELL & ASSOCIATES.
- 5. CONTOUR INTERVAL IS TWO FOOT (2').

INVERT

LEGEND

(NOT ALL FEATURES CONTAINED IN THIS LEGEND APPEAR ON THE PLAN)

		BOUNDARY LINE
		ABUTTING PROPERTY LINE
S	s	SEWER SERVICE
D	D	DRAIN SERVICE
——————————————————————————————————————		WATER SERVICE
G	G	GAS LINE
E	E	ELECTRIC LINE
— Т	Т	TELEPHONE LINE
ohw	— ohw ———	OVERHEAD WIRES
	× ×	CHAIN LINK FENCE
		STOCKADE FENCE
		INDEX CONTOUR
		INTERMEDIATE CONTOUR

		INTERMEDIATE	CONTOUR
0	UTILITY POLE	CC	CONCRETE CURB
#	LIGHT POLE	VGC	VERTICAL GRANITE CURB
	ELECTRIC HAND HOLE	BCB	BITUMINOUS CONCRETE CURB
0	CABLE MANHOLE	HC	HANDICAP
S	SEWER MANHOLE	HPDE	HIGH DENSITY POLYETHYLENE
D	DRAIN MANHOLE	CONC.	CONCRETE
\blacksquare	CATCH BASIN	LSA	LANDSCAPE AREA
×	WATER VALVE	V	DOOR
∜	FIRE HYDRANT	d	SIGN
0	SPRINKLER CONNECTION	(8)/(8C)	PARKING COUNT / COMPACT
0	POST INDICATOR VALVE		NUMBER
•	BOLLARD	(+ ;	DECIDUOUS TREE
П	GAS METER		
\bowtie	GAS VALVE		CONIFEROUS TREE
	ROOF DRAIN	(REC)	FROM RECORD PLANS
0	AREA DRAIN		RETAINING WALL
	IRRIGATION CONTROL VALVE	[00077000]	
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	TEST PIT	99x5	PROPOSED SPOT GRADE

	TEST PIT	99x5	PROPOSED SPOT GRADE
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	PROPOSED TREELINE		LIMIT OF RIVERFRONT AREA
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	PROPOSED FLARED END	———PW——	PROPOSED WATER SERVICE

PD—PD—PROPOSED DRAIN LINE


ATRIOT Engineeri



CONSTRUCTION PLAN

SHEET 3 of 6

102

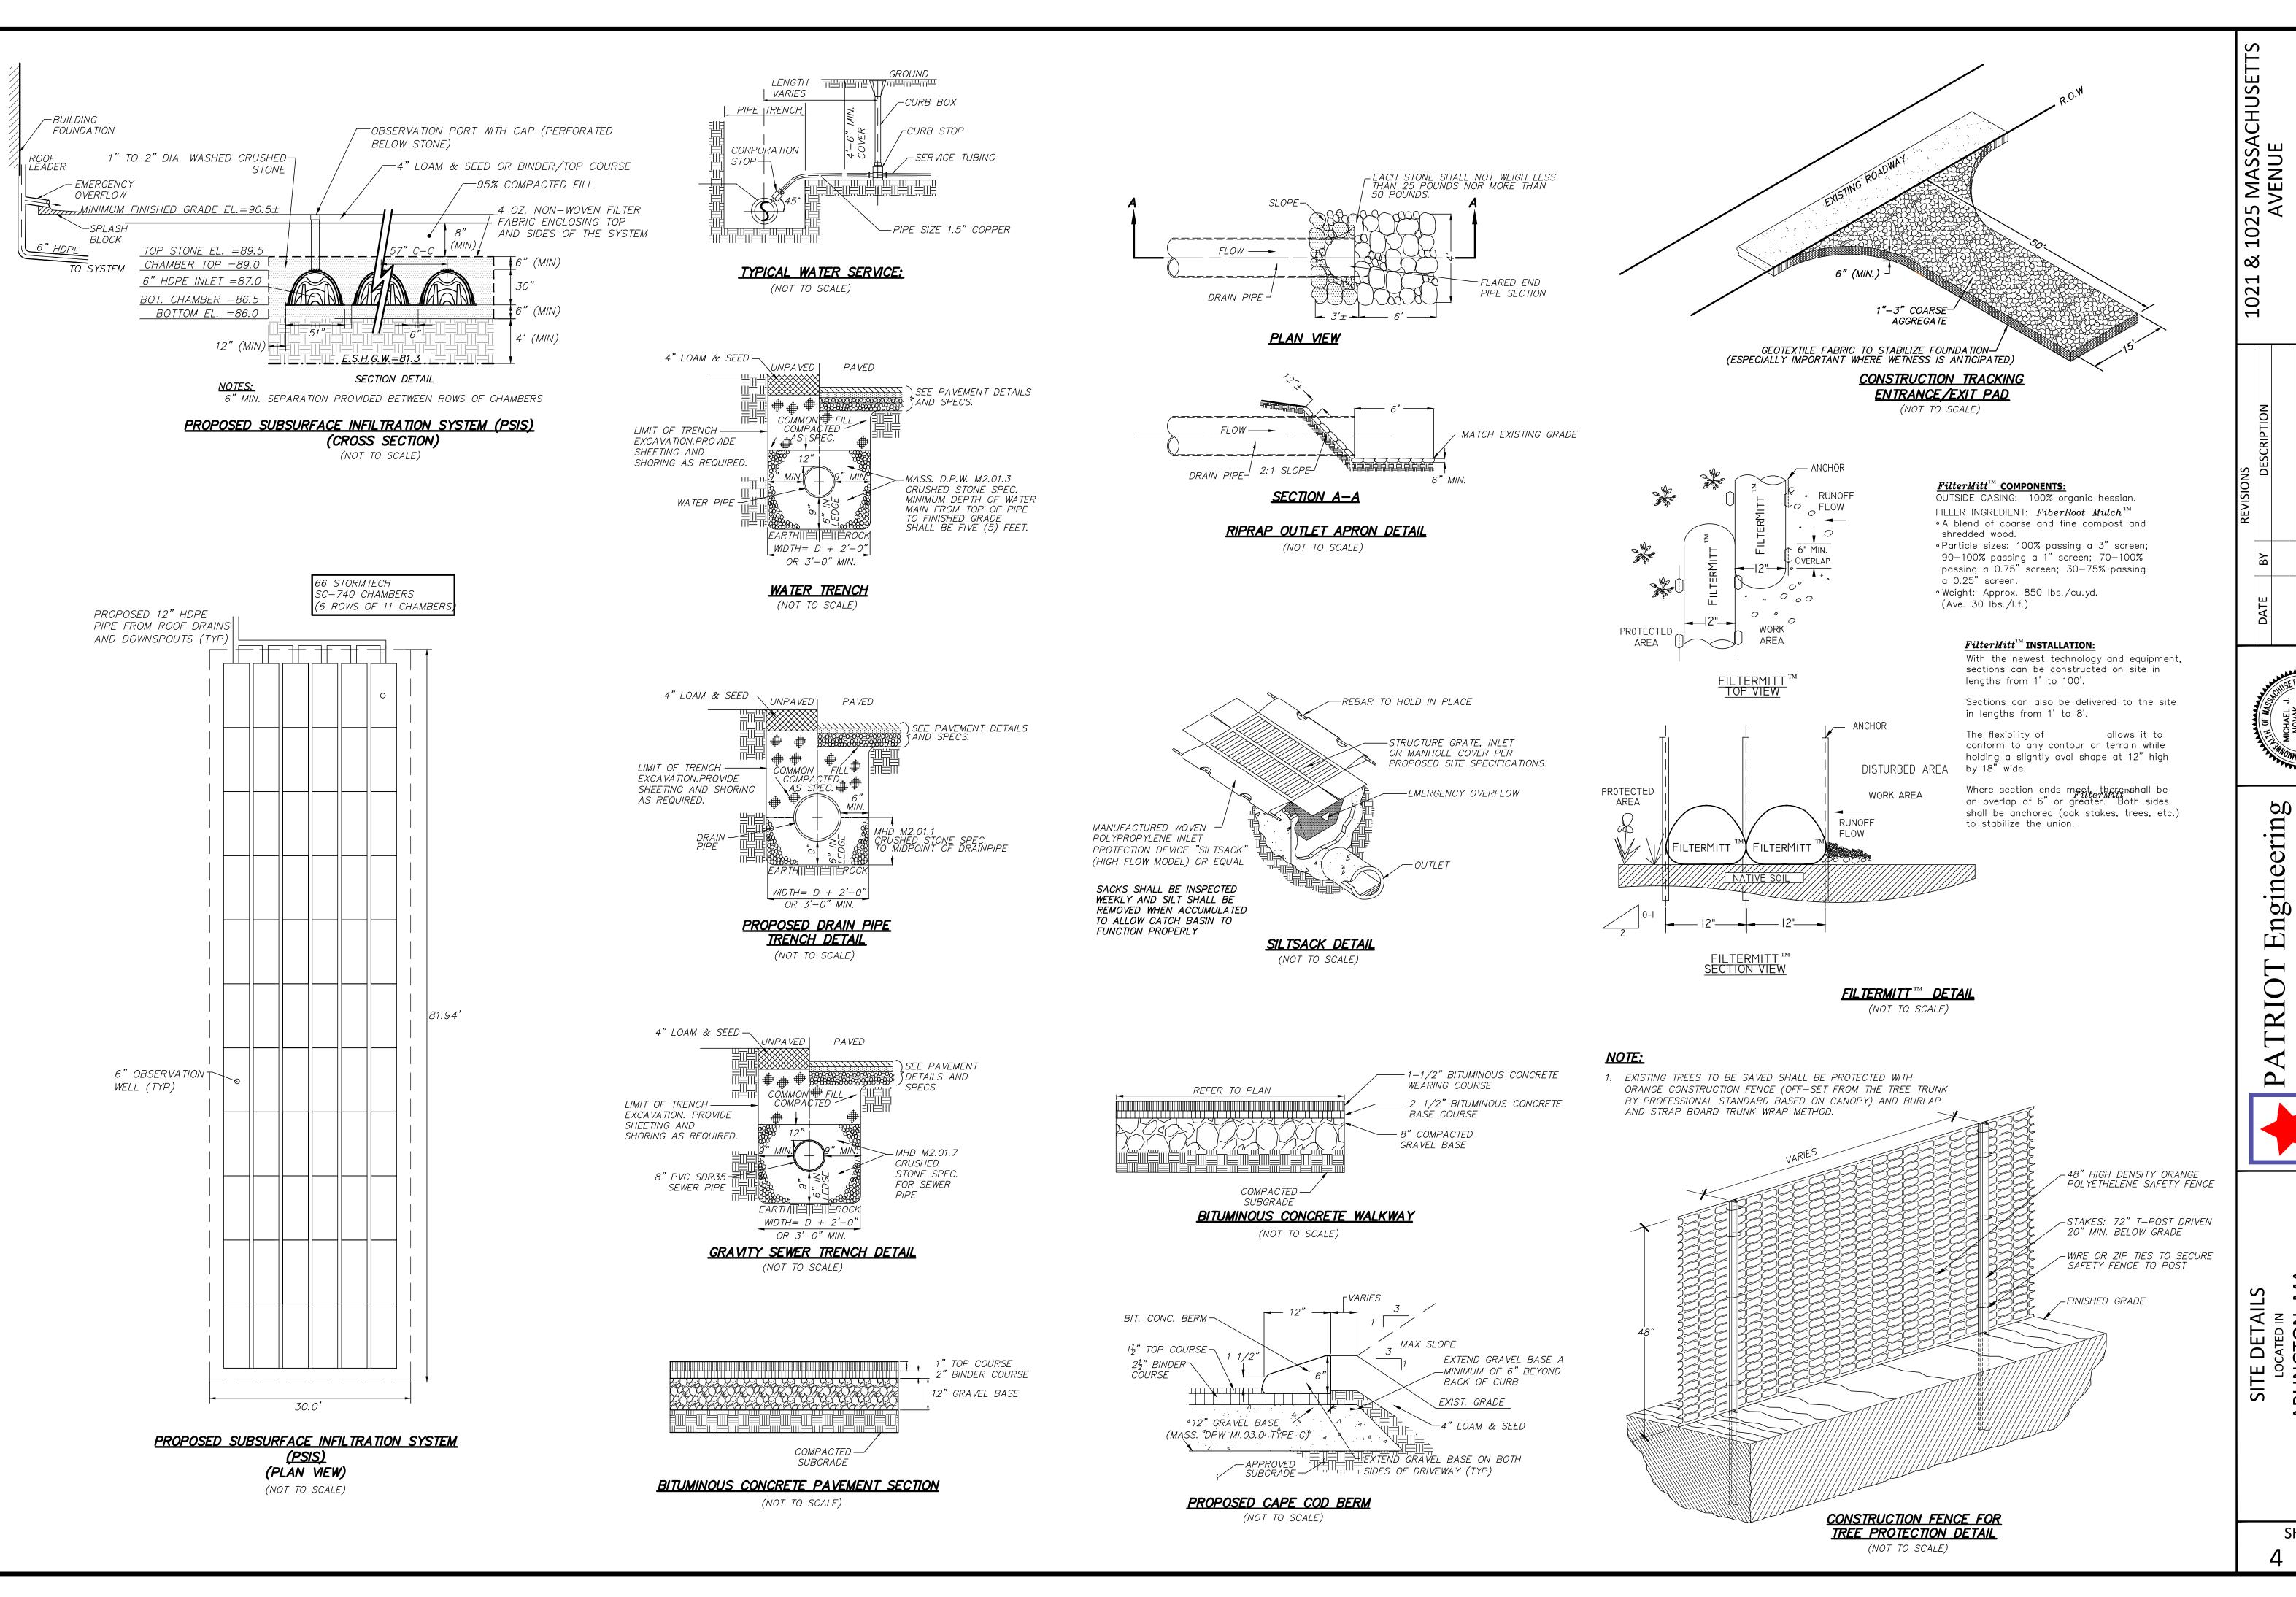

1025 MASSACHUSETT AVENUE MASSACHUSE TON, ARLING⁻

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ARLINGTON, (MIDDLESEX COL

SHEET

4 OF 6



- 1. THE PURPOSE OF THIS PLAN IS TO SHOW THE EXISTING SITE CONDITIONS, AS THEY EXISTED AT THE TIME OF THE FIELD SURVEY, OF THE LOCUS PARCEL FOR DESIGN PURPOSES. THIS PLAN WAS PREPARED FROM AN ACTUAL SURVEY MADE ON THE GROUND USING TOTAL STATION METHODS BY R. J. O'CONNELL & ASSOCIATES (RJOC).
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LEGEND

—— — — — ABUTTING PROPERTY LINE

(NOT ALL FEATURES CONTAINED IN THIS LEGEND APPEAR ON THE PLAN)

_	S	SEWER SERVICE	
———— W——	W	WATER SERVICE	E
——— G —	G	GAS LINE	
——— E —	E	ELECTRIC LINE	
— т —	т	TELEPHONE LIN	NE
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		INDEX CONTOU	R
		INTERMEDIATE	CONTOUR
0	UTILITY POLE	CC	CONCRETE CURB
禁	LIGHT POLE	VGC	VERTICAL GRANITE CURB
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	CATCH BASIN	LSA	LANDSCAPE AREA
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0	SPRINKLER CONNECTION POST INDICATOR VALVE	8/80	PARKING COUNT / COMPACT NUMBER
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	ROOF DRAIN	(REC)	FROM RECORD PLANS
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PSIS	PROPOSED SUBSURFACE INFILTRATION SYSTEM	<u>99</u> ·	PROPOSED CONTOUR PROPOSED CONTOUR
·	PROPOSED FILTERMITT	\times	TREE PROPOSED TO BE REMOVED
	PROPOSED TREELINE		LIMIT OF RIVERFRONT AREA
			DDODOCED CEWED CEDVICE

PROPOSED FLARED END

INVERT

1021 & 1025 MASSACHUSETTS
AVENUE
ARLINGTON, MA
DRAWN BY: DATE: 4-27-2022

DATE BY DESCRIPTION

DATE BY DESCRIPTION

DRAY

CHE

PATRIOT Engineeri
SE BEDFORD STREET, SUITE 4
EXINGTON, MASSACHUSETTS 02420
SE (978) 726-2654

PA 35 BEI LEXINO T: (97)

BY RITE SITE PLAN
LOCATED IN
ARLINGTON, MA
(MIDDLESEX COUNTY)
PREPARED FOR

SHEET 5 OF 6

NOTES TO USERS

This map is for use in administering the National Flood Insurance Program. It does not necessarily identify all areas subject to flooding, particularly from local drainage sources of small size. The community map repository should be consulted for possible updated or additional flood hazard information.

To obtain more detailed information in areas where Base Flood Elevations (BFEs) and/or floodways have been determined, users are encouraged to consult the Flood Profiles and Floodway Data and/or Summary of Stillwater Elevations tables contained within the Flood Insurance Study (FIS) report that accompanies this FIRM. Users should be aware that BFEs shown on the FIRM represent rounded whole-foot elevations. These BFEs are intended for flood insurance rating purposes only and should not be used as the sole source of flood elevation information. Accordingly, flood elevation data presented in the FIS report should be utilized in conjunction with the FIRM for purposes of construction and/or floodplain management.

Coastal Base Flood Elevations shown on this map apply only landward of 0.0' National North American Vertical Datum of 1988 (NAVD 88). Users of this FIRM should be aware that coastal flood elevations are also provided in the Summary of Stillwater Elevations tables in the Flood Insurance Study report for this jurisdiction. Elevations shown in the Summary of Stillwater Elevations tables should be used for construction and/or floodplain management purposes when they are higher than the elevations shown on this FIRM.

Boundaries of the floodways were computed at cross sections and interpolated between cross sections. The floodways were based on hydraulic considerations with regard to requirements of the National Flood Insurance Program. Floodway widths and other pertinent floodway data are provided in the Flood Insurance Study report for this jurisdiction.

Certain areas not in Special Flood Hazard Areas may be protected by flood control structures. Refer to Section 2.4 "Flood Protection Measures" of the Flood Insurance Study report for information on flood control structures for this

The projection used in the preparation of this map was Massachusetts State Plane Mainland zone (FIPSZONE 2001), meters. The horizontal datum was NAD 83, GRS80 spheroid. Differences in datum, spheroid, projection or State Plane zones used in the production of FIRMs for adjacent jurisdictions may result in slight positional differences in map features across jurisdiction boundaries. These differences do not affect the accuracy of this FIRM.

Flood elevations on this map are referenced to the North American Vertical Datum of 1988. These flood elevations must be compared to structure and ground elevations referenced to the same vertical datum. For information regarding conversion between the National Geodetic Vertical Datum of 1929 and the North American Vertical Datum of 1988, visit the National Geodetic Survey website at http://www.ngs.noaa.gov or contact the National Geodetic Survey at the following address:

NGS Information Services NOAA, N/NGS12 National Geodetic Survey SSMC-3, #9202 1315 East-West Highway Silver Spring, Maryland 20910-3282 (301) 713-3242

To obtain current elevation, description, and/or location information for bench marks shown on this map, please contact the Information Services Branch of the National Geodetic Survey at (301) 713-3242, or visit its website at http://www.ngs.noaa.gov.

Base map information shown on this FIRM was provided in digital format by the Office of Geographic and Environmental Information (MassGIS), Commonwealth of Massachusetts, Executive Office of Energy and Environmental Affairs. This information was derived from digital orthophotos produced at a scale of 1:5,000 from aerial photography dated April 2005.


This map reflects more detailed and up-to-date stream channel configurations than those shown on the previous FIRM for this jurisdiction. The floodplains and floodways that were transferred from the previous FIRM may have been adjusted to conform to these new stream channel configurations. As a result, the Flood Profiles and Floodway Data tables in the Flood Insurance Study Report (which contains authoritative hydraulic data) may reflect stream channel distances that differ from what is shown on this map.


Corporate limits shown on this map are based on the best data available at the time of publication. Because changes due to annexations or de-annexations may community officials to verify current corporate limit locations.

Please refer to the separately printed Map Index for an overview map of the county showing the layout of map panels; community map repository addresses; and a Listing of Communities table containing National Flood Insurance Program dates for each community as well as a listing of the panels on which each community is located.

Contact the FEMA Map Service Center at 1-800-358-9616 for information on available products associated with this FIRM. Available products may include previously issued Letters of Map Change, a Flood Insurance Study report, and/or digital versions of this map. The FEMA Map Service Center may also be reached by Fax at 1-800-358-9620 and its website at http://msc.fema.gov.

If you have **questions about this map** or questions concerning the National Flood Insurance Program in general, please call **1-877-FEMA MAP** (1-877-336-2627) or visit the FEMA website at http://www.fema.gov.

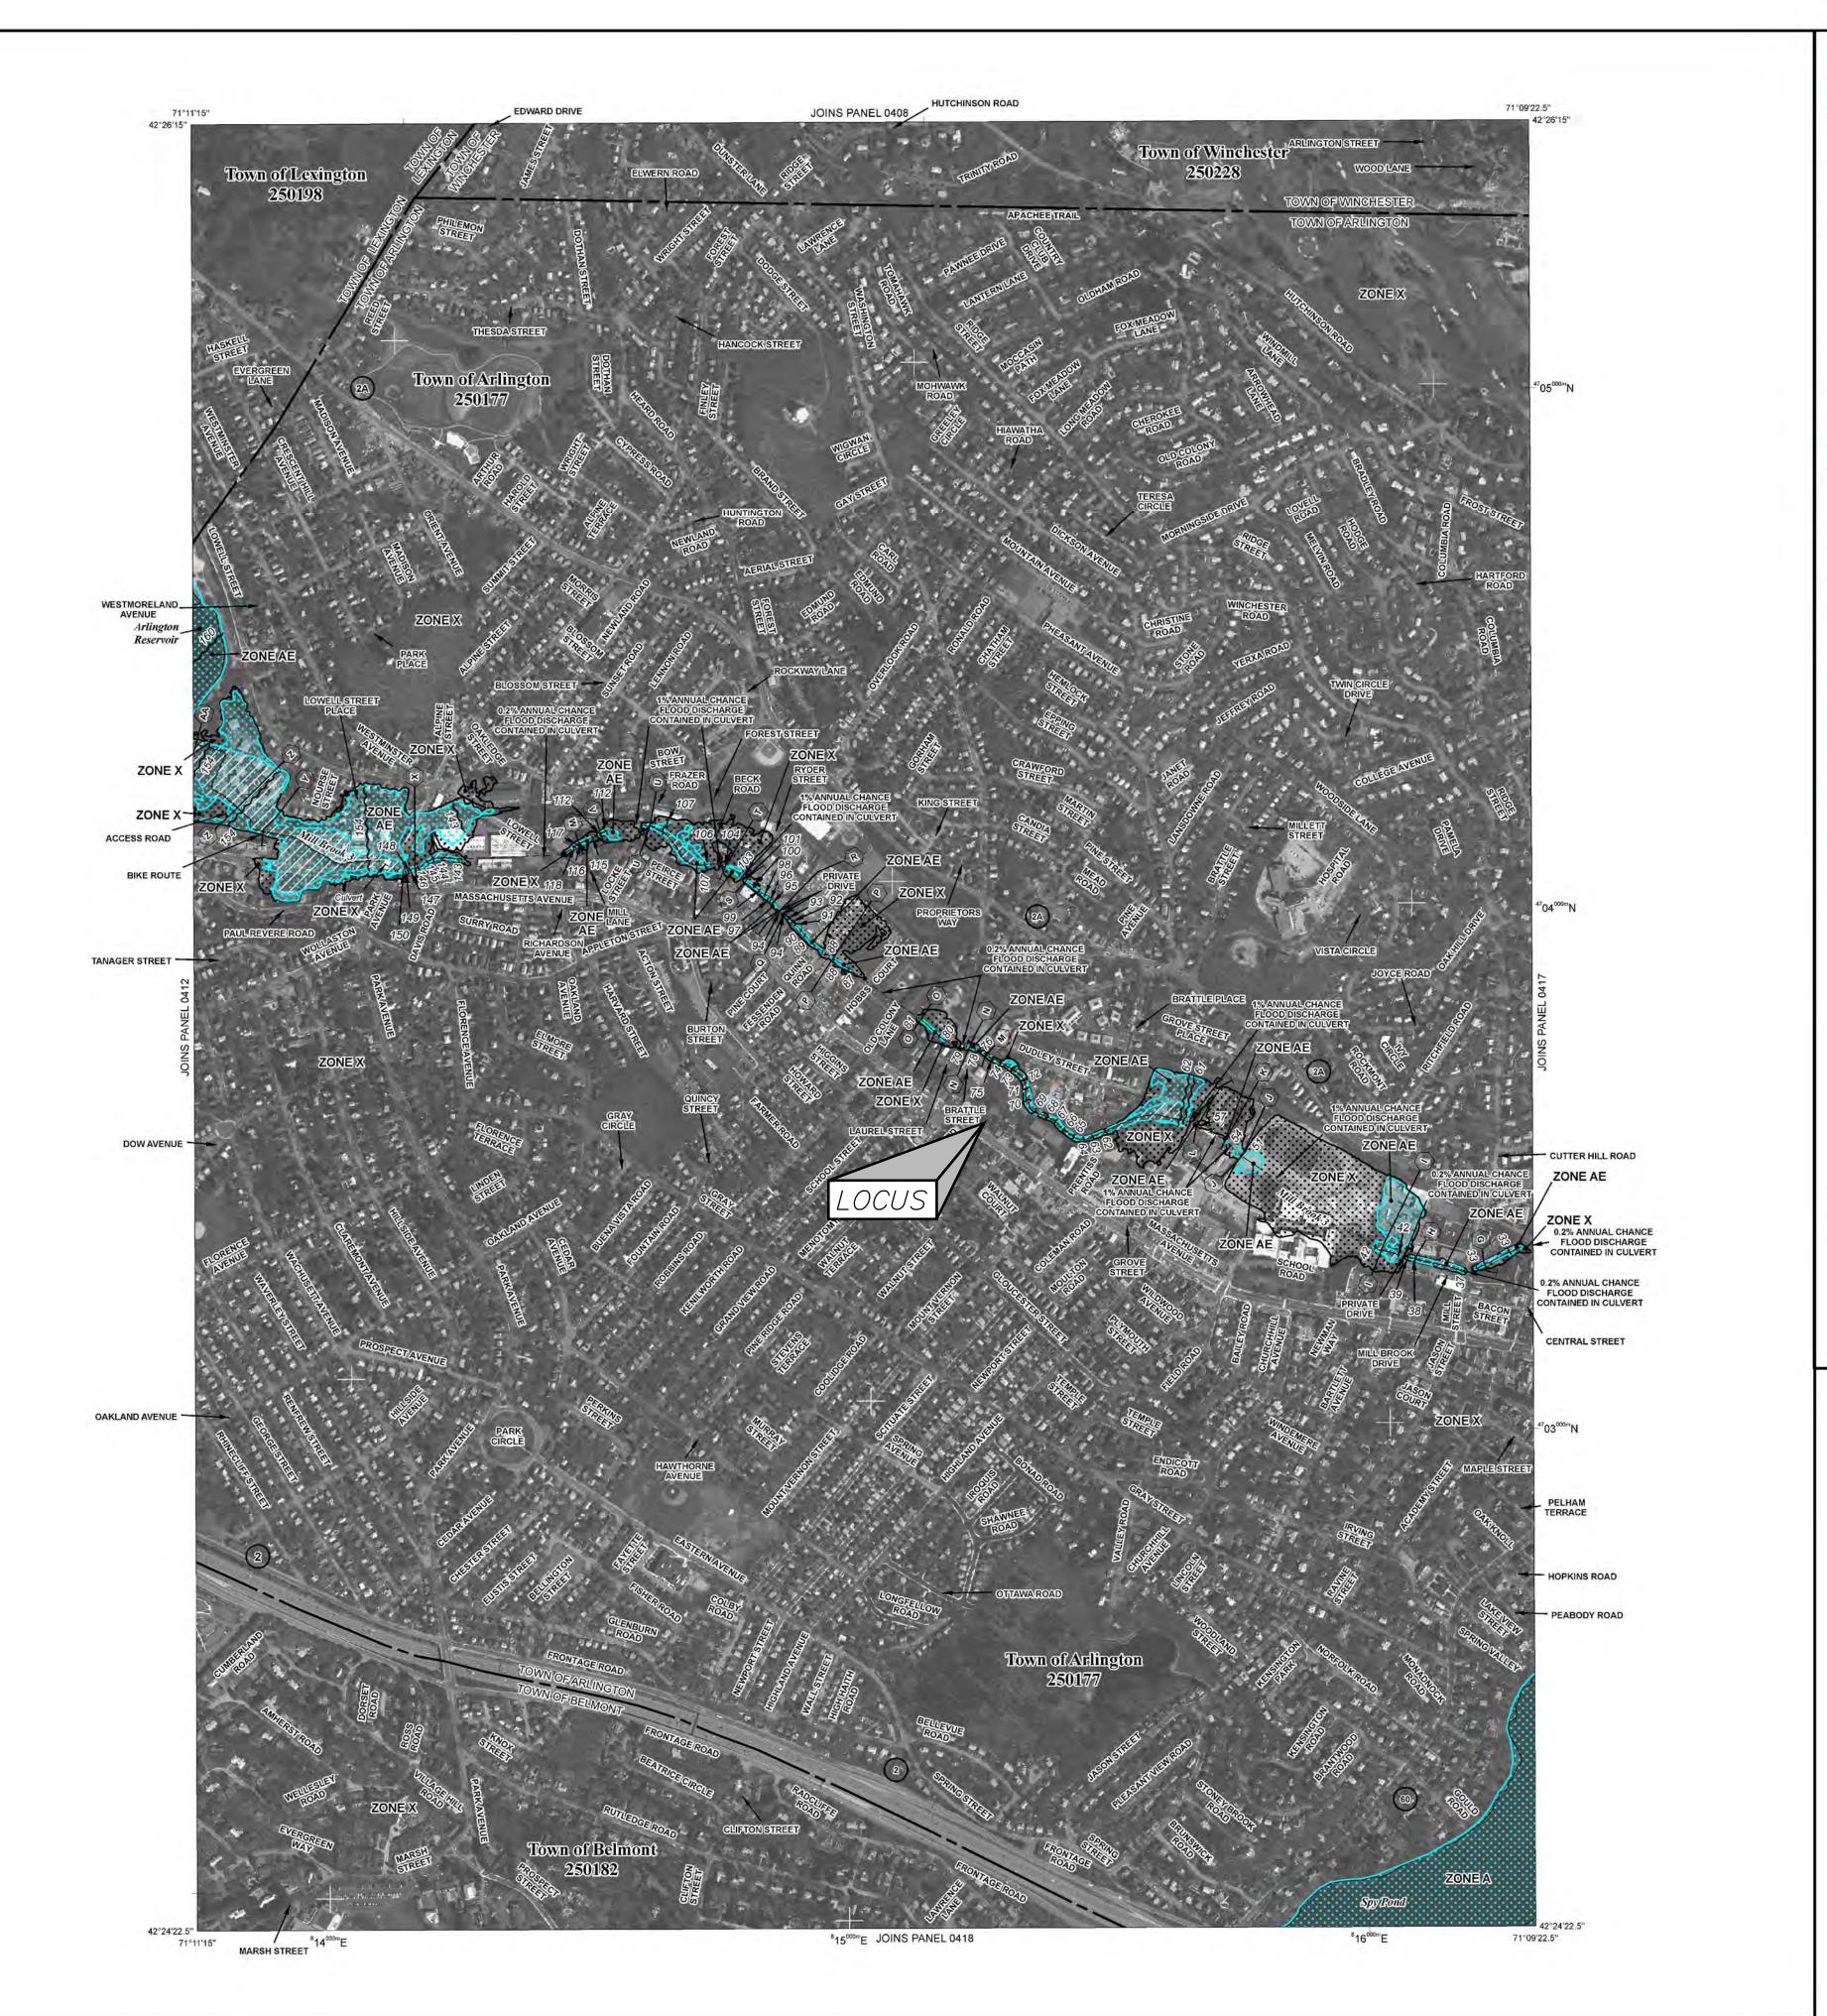

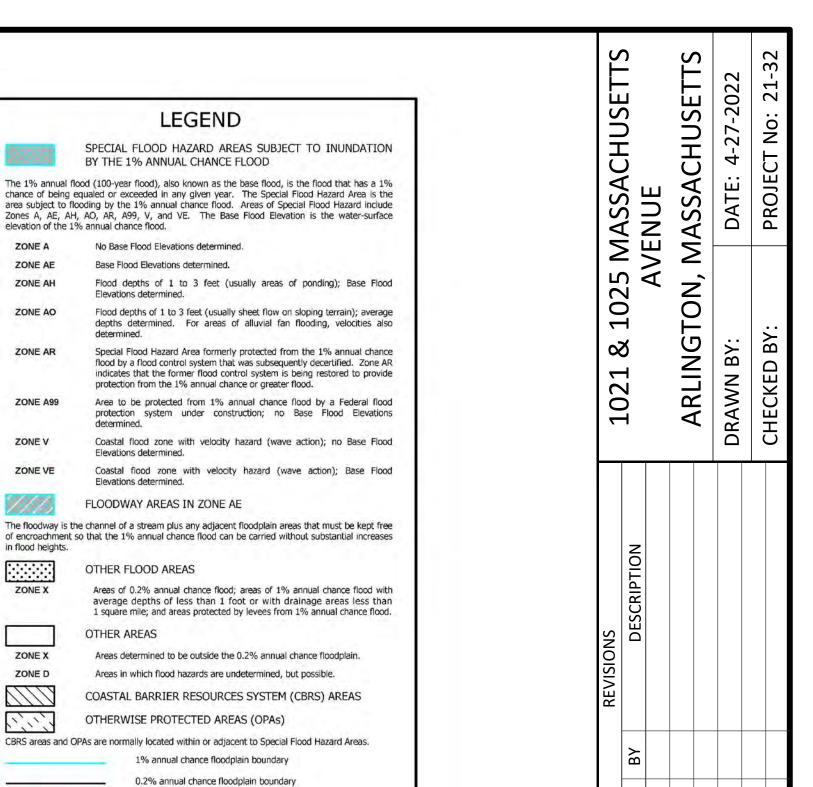

MAP REPOSITORY Refer to listing of Map Repositories on Map Index EFFECTIVE DATE OF COUNTYWIDE FLOOD INSURANCE RATE MAP June 4, 2010

Zone D boundary

Cross section line

River Mile

Boundary dividing Special Flood Hazard Area Zones and - boundary dividing Special Flood Hazard Areas of different Base

Base Flood Elevation value where uniform within zone; elevation

Geographic coordinates referenced to the North American

1000-meter Universal Transverse Mercator grid values, zone

5000-foot grid values: Massachusetts State Plane coordinate

system, Mainland zone (FIPSZONE 2001), Lambert Conformal

Bench mark (see explanation in Notes to Users section of this

Flood Elevations, flood depths or flood velocities.

Datum of 1983 (NAD 83), Western Hemisphere

Base Flood Elevation line and value; elevation in feet*

CBRS and OPA boundary

* Referenced to the North American Vertical Datum of 1988

87°07'45", 32°22'30"

600000 FT

DX5510 ×

• M1.5

ZONE X


EFFECTIVE DATE(S) OF REVISION(S) TO THIS PANEL For community map revision history prior to countywide mapping, refer to the Community

To determine if flood insurance is available in this community, contact your Insurance

Map History table located in the Flood Insurance Study report for this jurisdiction.



(SCALE 1" = 600')

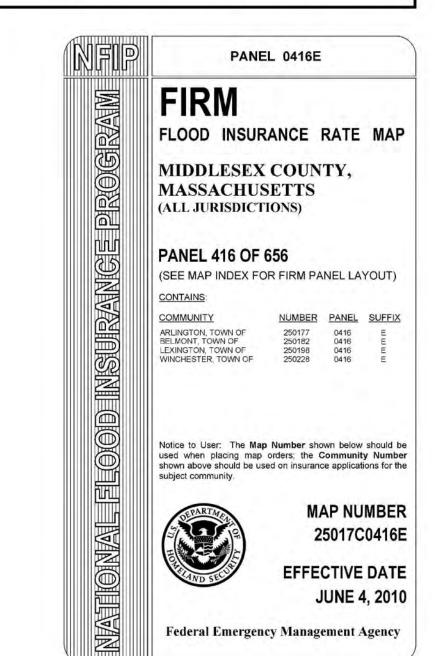



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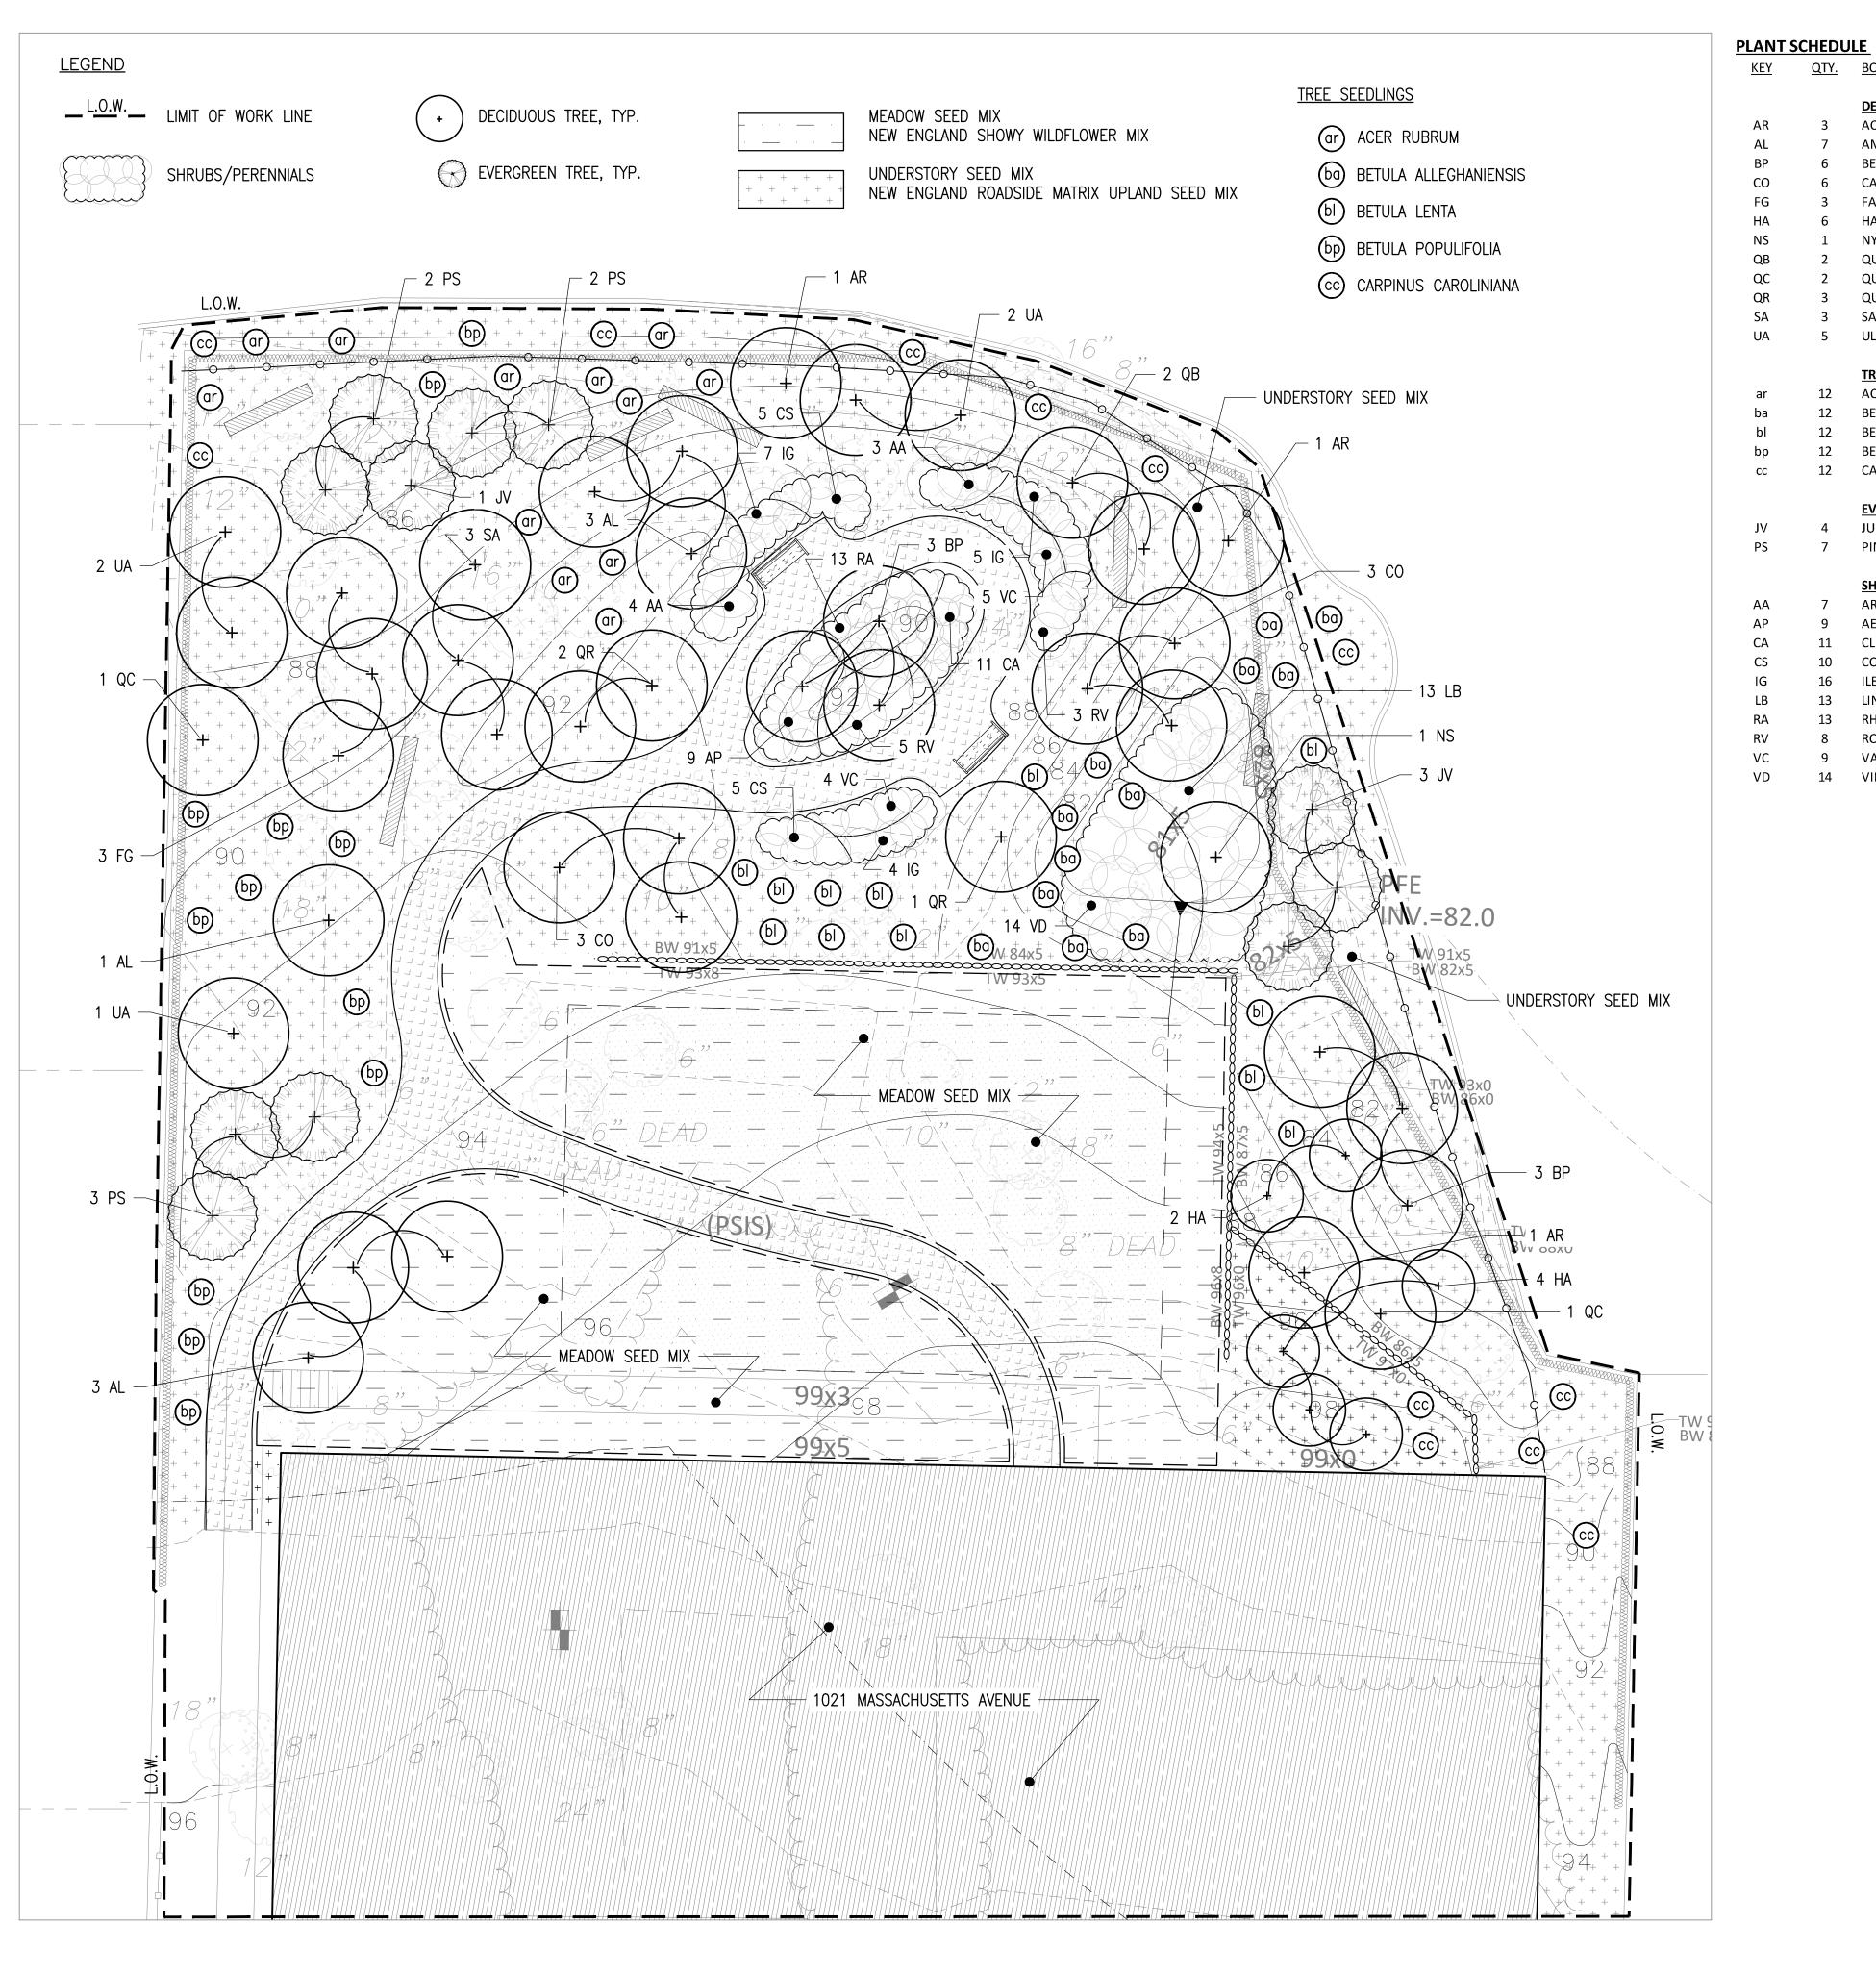
FEMA

SHEET 6 of 6





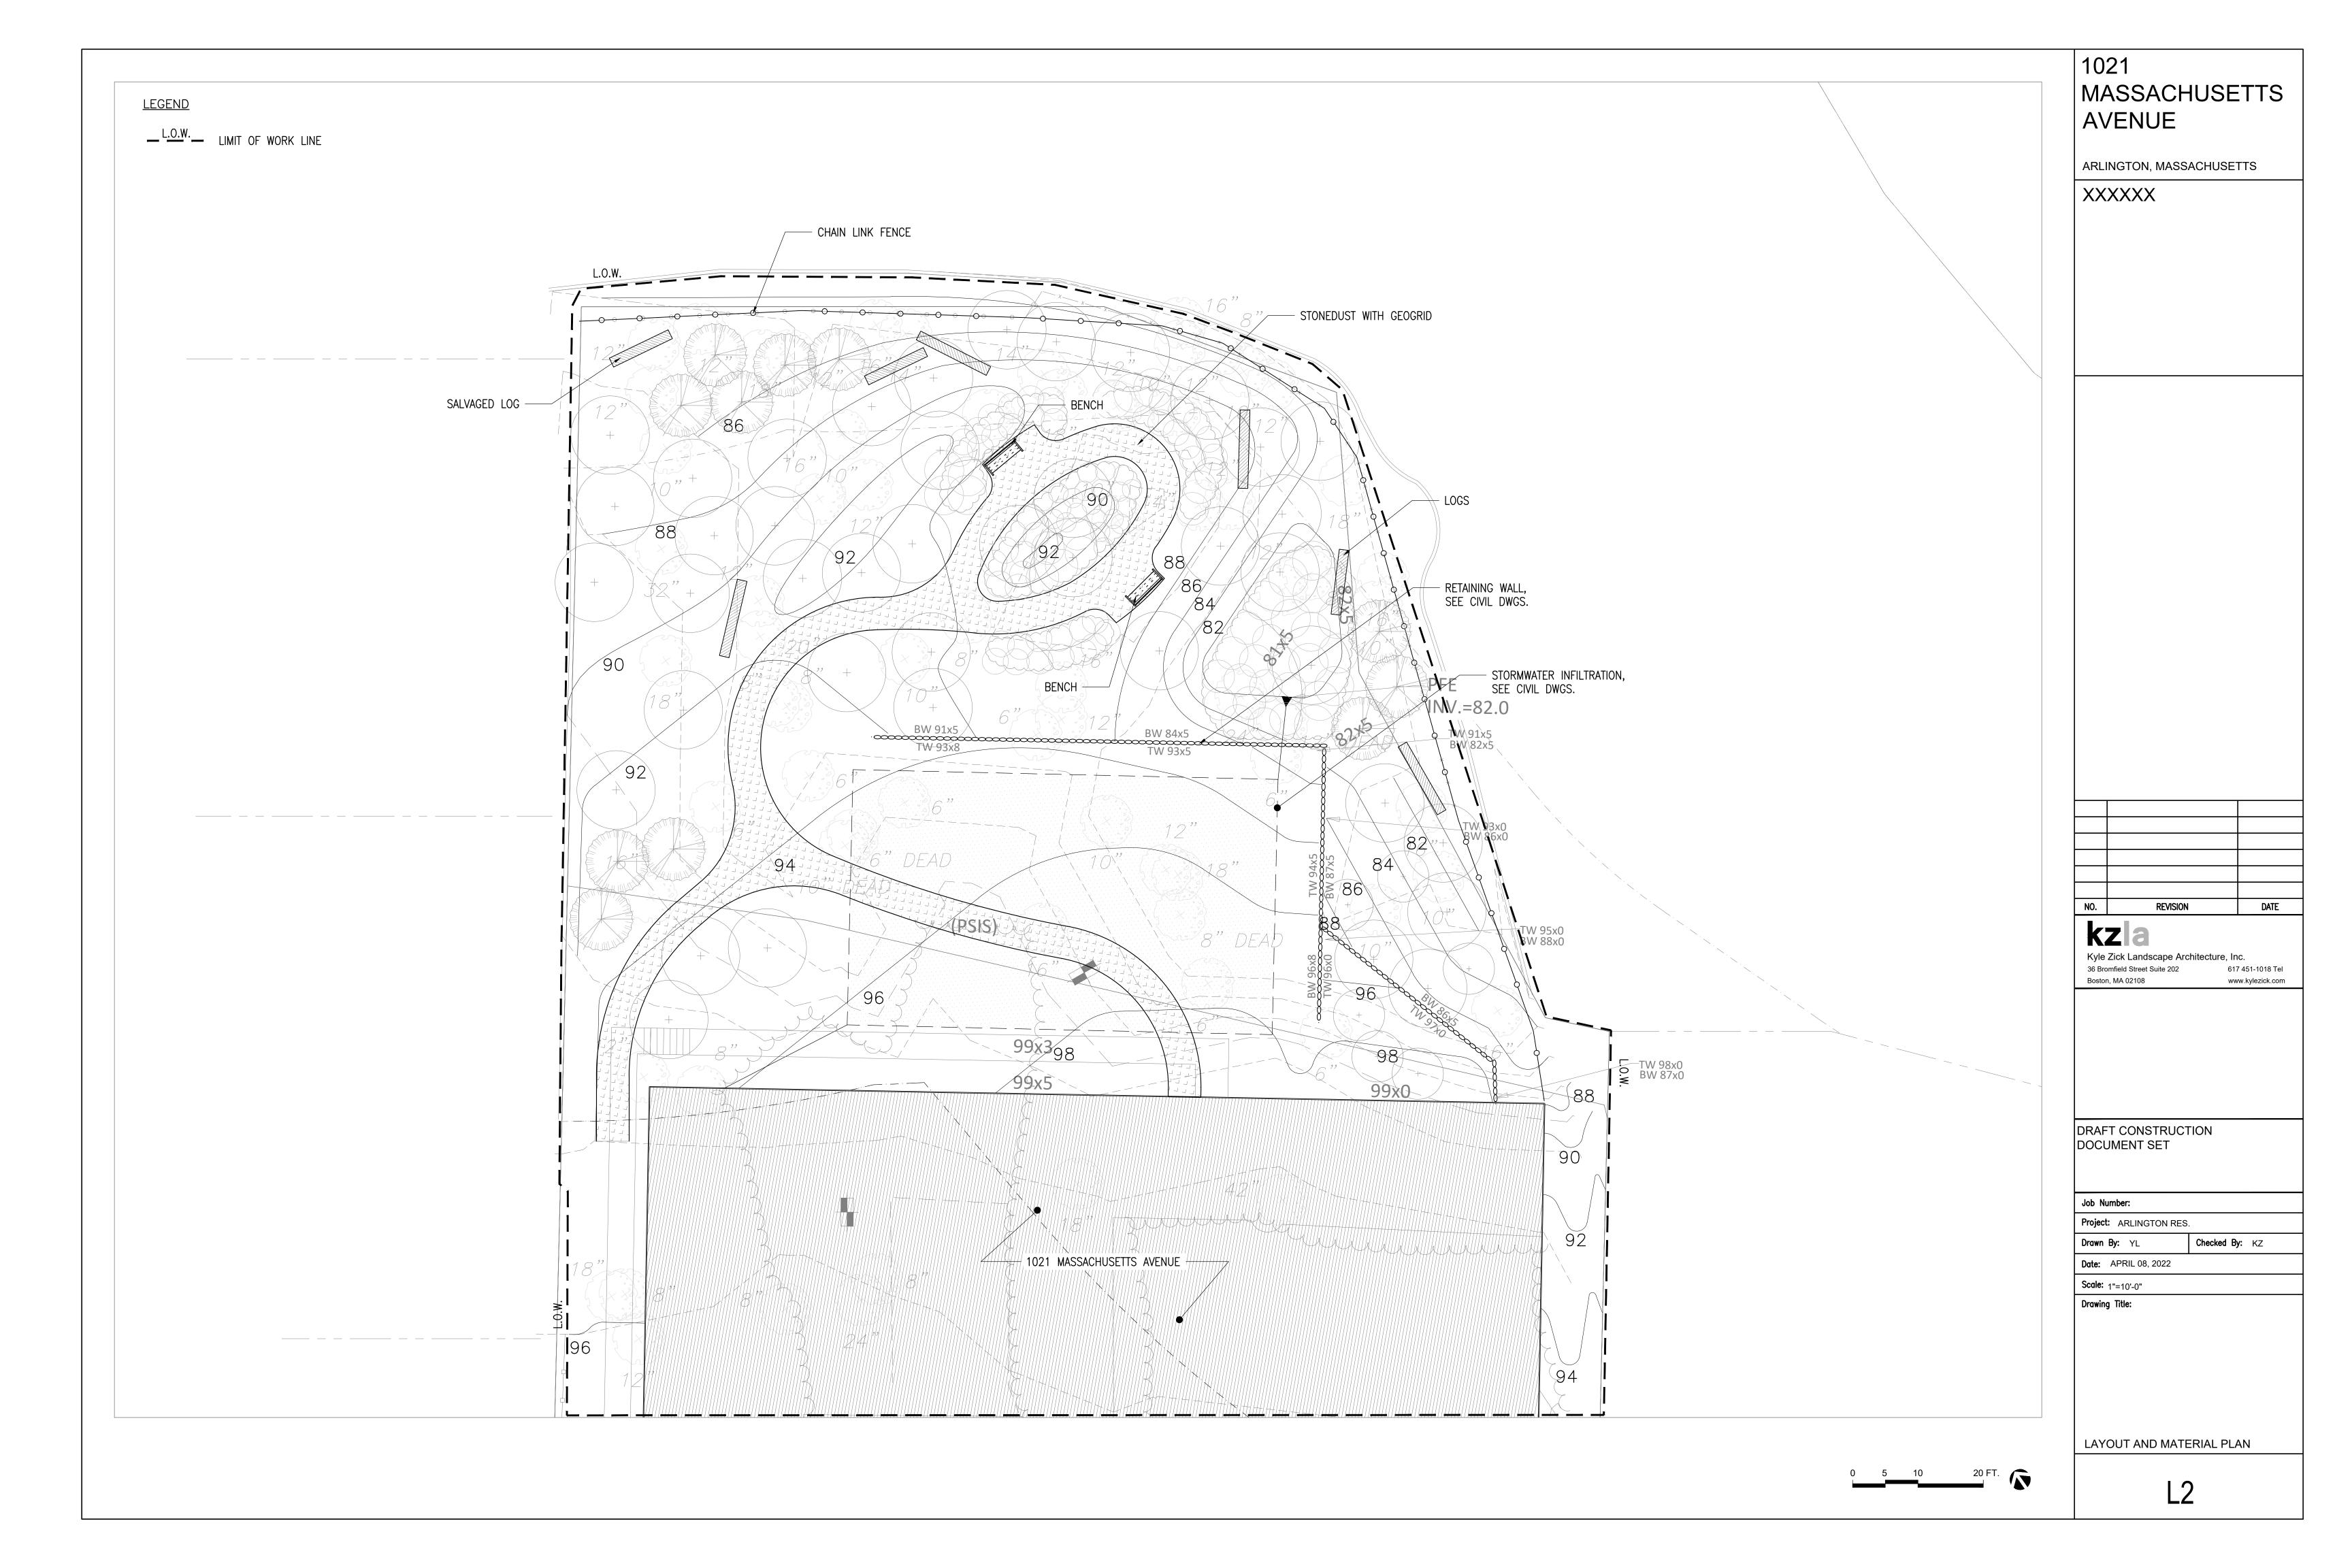

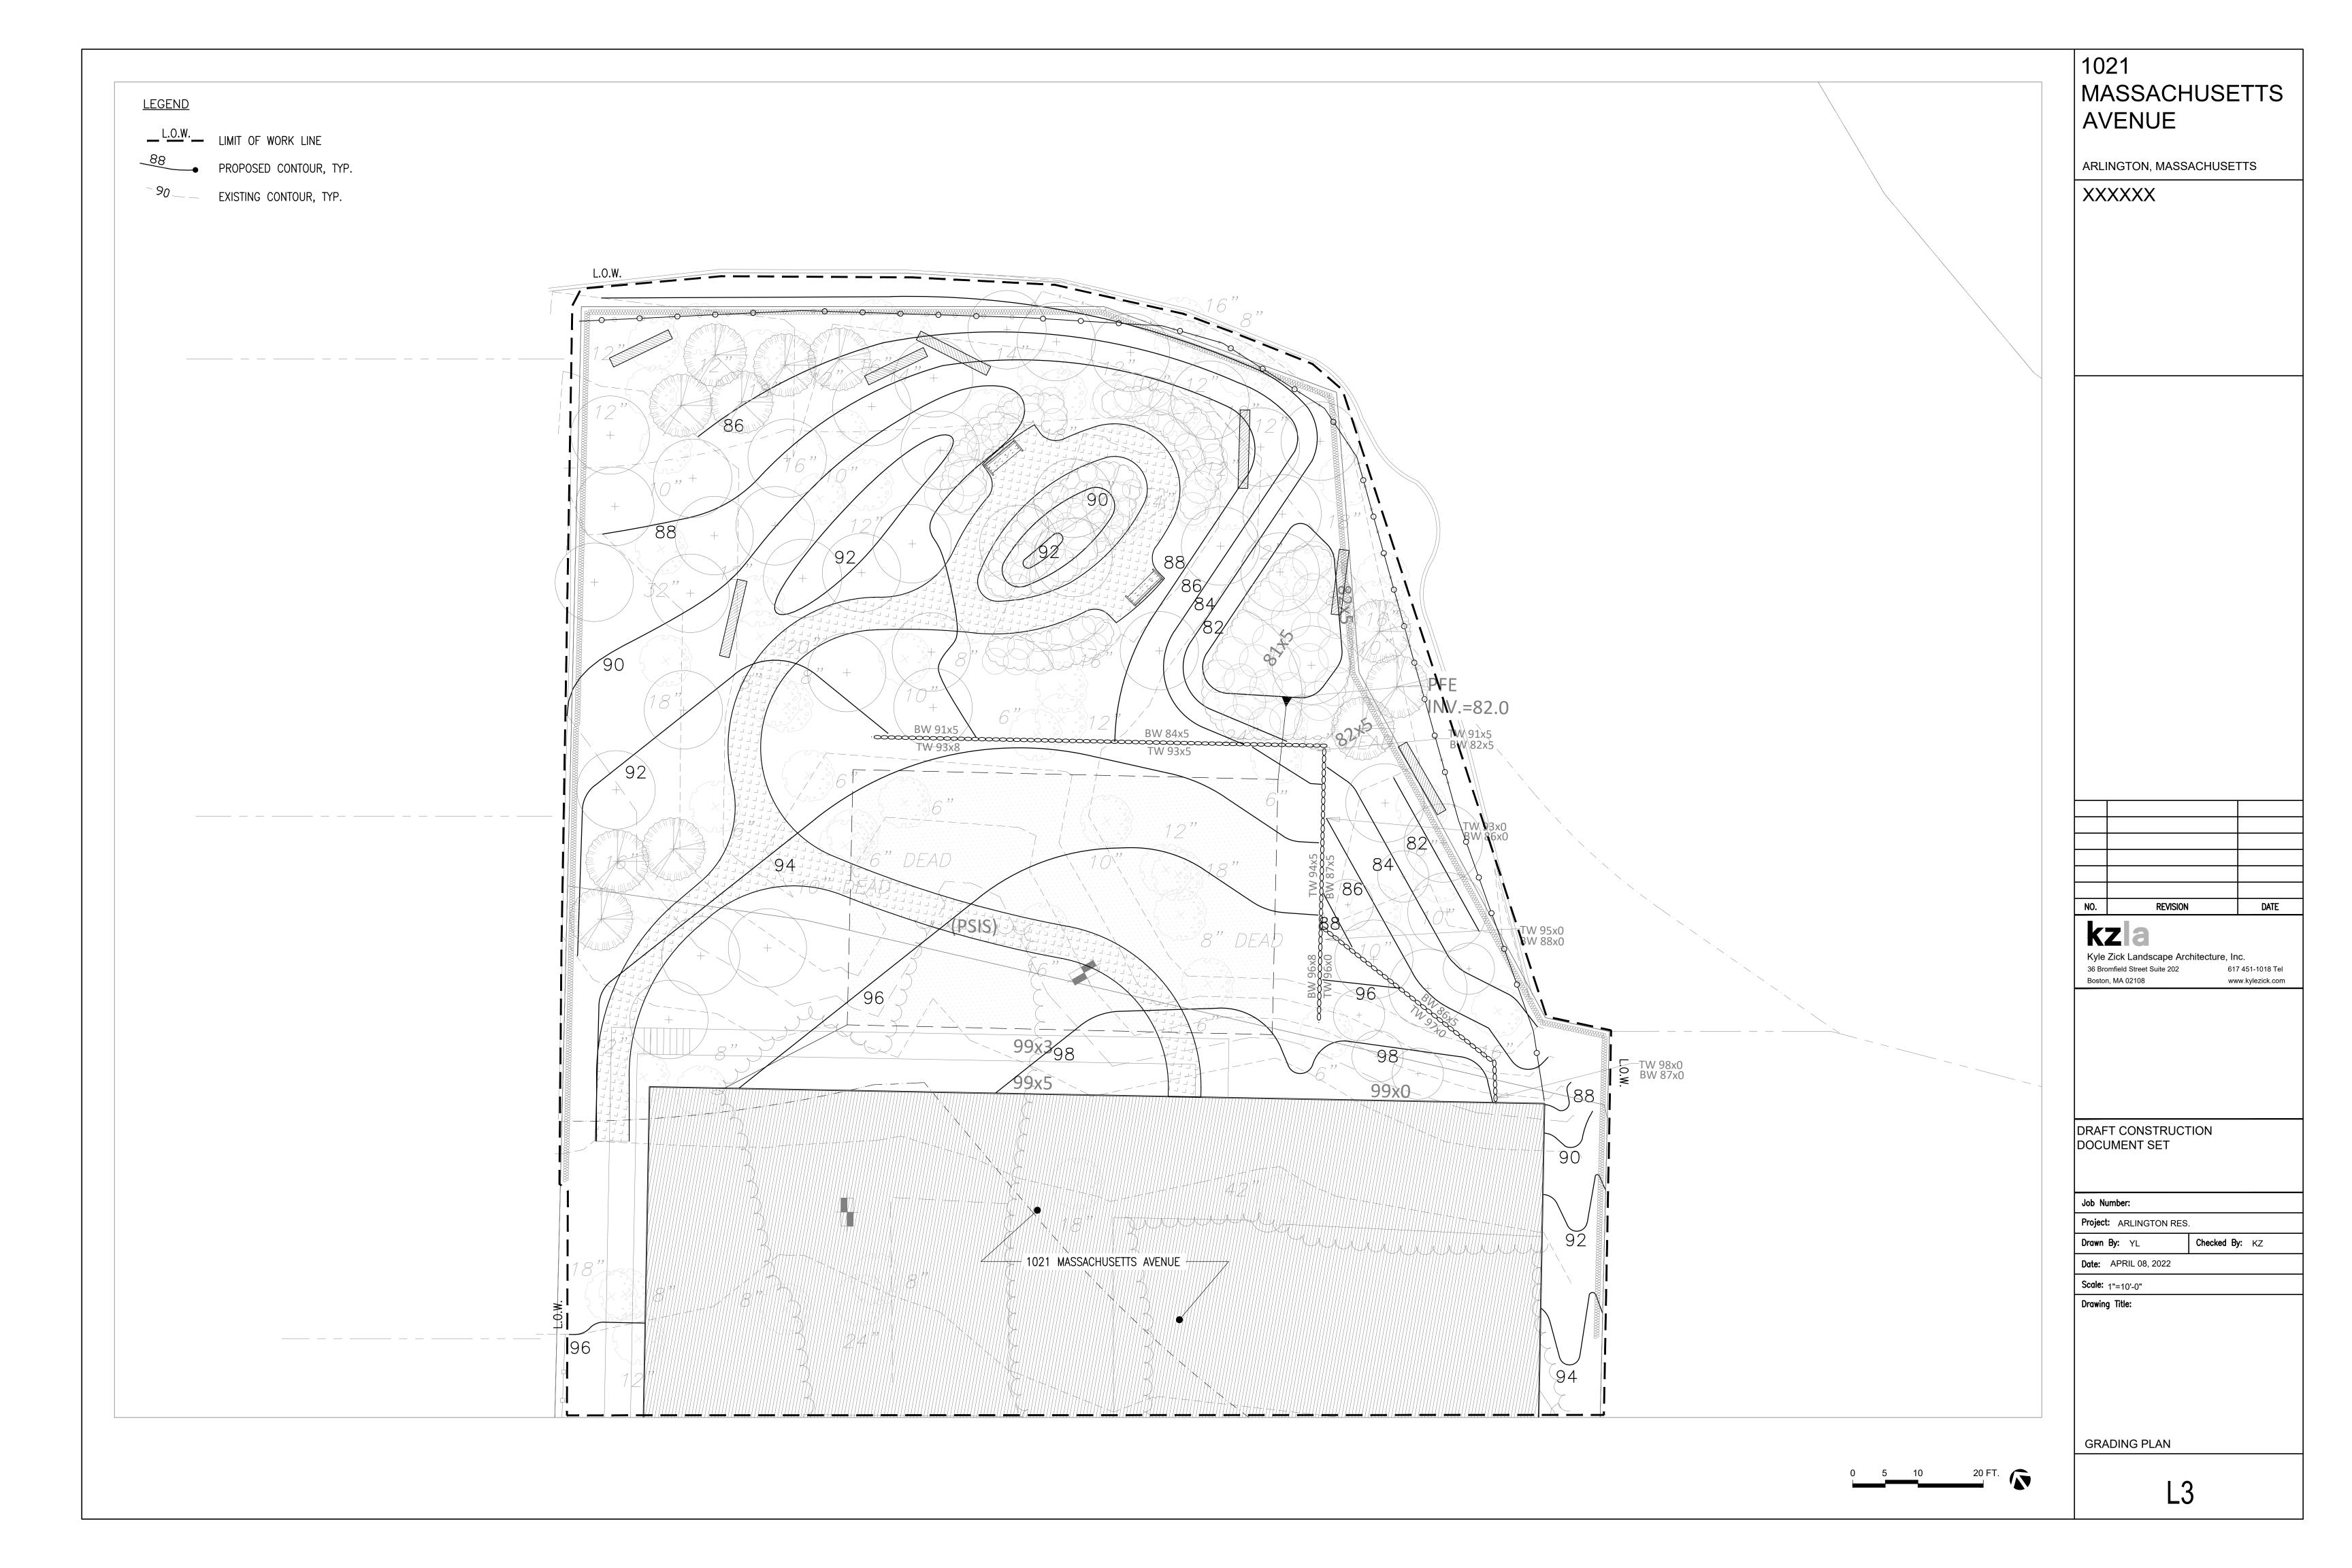

<u>KEY</u>	<u>QTY.</u>	BOTANICAL NAME	COMMON NAME	SIZE	<u>SPACING</u>	NOTES:
		DECIDUOUS TREES				
AR	3	ACER RUBRUM	RED MAPLE	2" CAL.	-	SPRING DIG ONL
AL	7	AMELANCHIER CANADENSIS L. MEDIK.	SHADBLOW SERVICEBERRY	12' HT.	-	MULTI-STEM
BP	6	BETULA PAPYRIFERA	PAPER BIRCH	12' HT.	-	MULTI-STEM
CO	6	CARYA OVATA	SHAGBARK HICKORY	1" CAL.	-	-
FG	3	FAGUS GRANDIFLORA	AMERICAN BEECH	1" CAL.	-	SPRING DIG ONL
HA	6	HAMAMELIS X INTERMEDIA 'ARNOLD PROMISE'	WITCHHAZEL	8' B&B	-	CLUMP FORM
NS	1	NYSSA SYLVATICA	SOURGUM	2" CAL.	-	SPRING DIG ONL
QB	2	QUERCUS BICOLOR	SWAMP WHITE OAK	2" CAL.	-	SPRING DIG ONL
QC	2	QUERCUS COCCINEA	SCARLET OAK	2" CAL.	-	SPRING DIG ONL
QR	3	QUERCUS RUBRA	RED OAK	2" CAL.	-	SPRING DIG ONL
SA	3	SASSAFRAS ALBIDUM	SASSAFRAS	1" CAL.	-	-
UA	5	ULMUS AMERICANA 'PRINCETON'	PRINCETON AMERICAN ELM	2" CAL.	-	SPRING DIG ONL
		TREE SEEDLINGS				
ar	12	ACER RUBRUM	RED MAPLE	4' HT.	-	-
ba	12	BETULA ALLEGHANIENSIS	YELLOW BIRCH	4' HT.	-	-
bl	12	BETULA LENTA	SWEET BIRCH	4' HT.	-	-
bp	12	BETULA POPULIFOLIA	GRAY BIRCH	4' HT.	-	-
СС	12	CARPINUS CAROLINIANA	AMERICAN HORNBEAM	4' HT.	-	-
		EVERGREEN TREES				
JV	4	JUNIPERUS VIRGINIANA	EASTERN RED CEDAR	6' HT.	-	-
PS	7	PINUS STROBUS	EASTERN WHITE PINE	6' HT.	-	-
		<u>SHRUBS</u>				
AA	7	ARONIA ARBUTIFOLIA	RED CHOKEBERRY	36" HT.	5'-0" O.C.	-
AP	9	AESCULUS PARVIFLORA	BOTTLEBRUSH BUCKEYE	36" HT.	4'-0" O.C.	-
CA	11	CLETHRA ALNIFOLIA	SUMMERSWEET	24" HT.	3'-0" O.C.	-
CS	10	CORNUS SERICEA	REDTWIG DOGWOOD	36" HT.	4'-0" O.C.	-
IG	16	ILEX GLABRA	INKBERRY	3 GAL.	4'-0" O.C.	-
LB	13	LINDERA BENZOIN	SPICEBUSH	36" HT.	6'-0" O.C.	-
RA	13	RHUS AROMATICA 'GRO-LOW'	GRO-LOW FRAGRANT SUMAC	24" SPREAD	3'-0" O.C.	-
RV	8	ROSA VIRGINIANA	VIRGINIA ROSE	36" HT.	5'-0" O.C.	-
VC	9	VACCINIUM CORYMBOSUM	HIGHBUSH BLUEBERRY	24" HT.	4'-0" O.C.	-
VD	14	VIBURNUM DENTATUM	ARROWWOOD	36" HT.	5'-0" O.C.	-

1021 MASSACHUSETTS AVENUE

ARLINGTON, MASSACHUSETTS

XXXXXX

NO. REVISION DATE

617 451-1018 Tel www.kylezick.com

Kyle Zick Landscape Architecture, Inc.
36 Bromfield Street Suite 202 617 45

DRAFT CONSTRUCTION DOCUMENT SET

Job Number:

Project: ARLINGTON RES.

Drawn By: YL Checked

Date: APRIL 08, 2022

Scale: 1"=10'-0"

Drawing Title:

PLANTING PLAN

L4

By-Right Site Plan



- 1. THE PURPOSE OF THIS PLAN IS TO SHOW THE EXISTING SITE CONDITIONS, AS THEY EXISTED AT THE TIME OF THE FIELD SURVEY, OF THE LOCUS PARCEL FOR DESIGN PURPOSES. THIS PLAN WAS PREPARED FROM AN ACTUAL SURVEY MADE ON THE GROUND USING TOTAL STATION METHODS BY R. J. O'CONNELL & ASSOCIATES (RJOC).
- 2. UNDERGROUND UTILITIES SHOWN ARE FROM OBSERVED SURFACE INDICATIONS, SUBSURFACE INDICATIONS, AND COMPILED FROM AVAILABLE RECORD PLANS OF UTILITY COMPANIES AND PUBLIC AGENCIES AND ARE APPROXIMATE ONLY. AS OF THE DATE OF THIS SURVEY, NO INFORMATION REGARDING RECORD UTILITIES HAS BEEN PROVIDED BY ELECTRIC AND GAS PROVIDERS. BEFORE CONSTRUCTION CALL "DIG SAFE" 811.
- 3. THE HORIZONTAL DATUM I IS THE MASSACHUSETTS COORDINATE SYSTEM (NAD83), THE VERTICAL DATUM IS NORTH AMERICAN VERTICAL DATUM OF 1988 (NAVD88). DATUMS WERE ESTABLISHED USING RTK GPS METHODS.
- 4. THE POSITIONAL ACCURACY OF THE DATA AND PHYSICAL IMPROVEMENTS ON THIS PLAN MAY BE APPROXIMATE. ANY USE OF ELECTRONIC DATA CONTAINED IN AUTOCAD VERSIONS OF THIS PLAN TO GENERATE COORDINATES OR DIMENSIONS NOT SHOWN ON THE PLAN IS NOT AUTHORIZED.

BOUNDARY LINE

- EDGE OF BANK-MEAN ANNUAL HIGH WATER LINE WAS DELINEATED BY LEC ENVIRONMENTAL CONSULTANTS, INC. ON OCTOBER 15, 2021 AND WAS LOCATED IN THE FIELD BY TOTAL STATION METHODS ON THE SAME DAY BY RJ O'CONNELL & ASSOCIATES.
- 6. CONTOUR INTERVAL IS TWO FOOT (2').

LEGEND

—— — — — ABUTTING PROPERTY LINE

(NOT ALL FEATURES CONTAINED IN THIS LEGEND APPEAR ON THE PLAN)

S_	S	SEWER SERVIC	
D	D	DRAIN SERVICE	<u> </u>
——————————————————————————————————————	W	WATER SERVIC	E
——— G —	G	GAS LINE	
——— E —	E	ELECTRIC LINE	
——— т —	Т ——	TELEPHONE LIN	NE .
ohw	ohw	OVERHEAD WIF	RES
X	× ×	CHAIN LINK FEN	ICE
	-000000000	STOCKADE FEN	CE
		INDEX CONTOU	₹
		INTERMEDIATE	CONTOUR
	UTILITY POLE	CC	CONCRETE CURB
禁	LIGHT POLE	VGC	VERTICAL GRANITE CURB
	ELECTRIC HAND HOLE	BCB	BITUMINOUS CONCRETE CURB
©	CABLE MANHOLE	HC	HANDICAP
S	SEWER MANHOLE	HPDE	HIGH DENSITY POLYETHYLENE
D	DRAIN MANHOLE	CONC.	CONCRETE
	CATCH BASIN	LSA	LANDSCAPE AREA
H	WATER VALVE	•	DOOR
\forall	FIRE HYDRANT	d	SIGN
0	SPRINKLER CONNECTION	8/8C	PARKING COUNT / COMPACT
0	POST INDICATOR VALVE		NUMBER
•	BOLLARD	3 + 3	DECIDUOUS TREE
	GAS METER	- 2	
\bowtie	GAS VALVE		CONIFEROUS TREE
	ROOF DRAIN	(REC)	FROM RECORD PLANS
0	AREA DRAIN		RETAINING WALL
	IRRIGATION CONTROL VALVE	00000000	
×114.7	SPOT GRADE	00000000	DETECTABLE WARNING PAD
₩	TEST PIT	99x5	PROPOSED SPOT GRADE
PSIS	PROPOSED SUBSURFACE INFILTRATION SYSTEM	<u>99</u> ·	PROPOSED CONTOUR PROPOSED CONTOUR
·	PROPOSED FILTERMITT	×	TREE PROPOSED TO BE REMOVED
	PROPOSED TREELINE	_ · _ · _ · _	LIMIT OF RIVERFRONT AREA
TYP	TYPICAL	——PS——	PROPOSED SEWER SERVICE

PROPOSED FLARED END

PW—PW—PROPOSED WATER SERVICE

1021 & 1025 MASSACHUSETTS
AVENUE
ARLINGTON, MA

DRAWN BY: DATE: 4-27-2022
CHECKED RY: PROJECT NO. 21-32

10) 		DRAV	1	CHEC
REVISIONS	DESCRIPTION				
	ВУ				
	DATE				

PATRIOT Engineeri
35 BEDFORD STREET, SUITE 4
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T: (978) 726-2654
www.patriot-eng.com

BY RITE SITE PLAN
LOCATED IN
ARLINGTON, MA
(MIDDLESEX COUNTY)

SHEET 6